- 2. THE CONTRACTOR SHALL NOTIFY THE CITY'S ENGINEERING DEPARTMENT AUTHORIZED REPRESENTATIVE 48 HOURS PRIOR TO THE BEGINNING OF WORK AT (760) 752-7550.
- 3. PRECISE LOCATIONS/ELEVATIONS OF THE EXISTING UNDERGROUND UTILITIES ARE NOT KNOWN. THE CONTRACTOR SHALL BE SOLELY RESPONSIBLE FOR MAKING EXPLORATIONS TO LOCATE ALL UTILITIES AND SUBSTRUCTURES WHETHER SHOWN OR NOT ON THE PLANS AND TO PROTECT THEM FROM ANY DAMAGE PRIOR TO AND DURING CONSTRUCTION. THE EXPENSE OF REPAIR OR REPLACEMENT OF SAID UTILITIES AND SUBSTRUCTURES SHALL BE BORNE BY THE CONTRACTOR. THE CONTRACTOR SHALL NOTIFY THE ENGINEERING DEPARTMENT AUTHORIZED REPRESENTATIVE OF ANY POTENTIAL CONFLICTS SUFFICIENTLY IN TIME FOR DESIGN CHANGES TO BE REVIEWED AND APPROVED.
- 4. THE CONTRACTOR SHALL CONTACT THE UNDERGROUND SERVICE ALERT AT 1-800-422-4133 AT LEAST 48 HOURS PRIOR TO EXCAVATING TO VERIFY THE LOCATIONS OF UNDERGROUND FACILITIES OF THE FOLLOWING UTILITIES:

VALLECITOS WATER DISTRICT:

ENG'G DEPT. 1-760-744-0460

COX COMMUNICATION: ADAM HIGBEE 1-619-266-5598 5159 FEDERAL BLVD. SAN DIEGO, CA

SDGE-GAS:

1-760-432-5864 571 ENTERPRISE ST. ESCONDIDO. CA CHARLIE ARCE

SDGE-ELECTRIC: JANY STALEY

1-858-636-5716 8315 CENTURY PARK CT. SAN DIEGO, CA

VALID PER GOVERNMENT CODE SECTION 4216/4217.

1-760-489-3198 950 W. WASHINGTON ST. ESCONDIDO, CA A DIG ALERT IDENTIFICATION NUMBER MUST BE ISSUED BEFORE A "PERMIT TO EXCAVATE" IS

5. "AS-BUILT" DRAWINGS SHALL BE SUBMITTED BY THE CONTRACTOR FOR ALL IMPROVEMENTS PRIOR TO ACCEPTANCE OF SAID IMPROVEMENTS IN ACCORDANCE WITH THE CONTRACT DOCUMENTS

- 6. CONTRACTOR SHALL BE RESPONSIBLE FOR ALL CONSTRUCTION ACCORDING TO THESE PLANS. THE CITY'S ENGINEERING DEPARTMENT AUTHORIZED REPRESENTATIVE SHALL BE CONTACTED PRIOR TO CHANGES OR ADDITIONS DURING THE PROGRESS OF CONSTRUCTION OR IF THERE IS A MISUNDERSTANDING OF THESE PLANS AND AN INTERPRETATION IS NEEDED.
- 7. THE CONTRACTOR SHALL BE RESPONSIBLE FOR PROTECTING ANY MONUMENTATION AND/OR BENCHMARKS. ANY MONUMENTATION AND/OR BENCHMARKS WHICH ARE DISTURBED OR DESTROYED BY CONSTRUCTION SHALL BE REPLACED AT THE CONTRACTOR'S EXPENSE, SUCH POINTS SHALL BE REPLACED WITH APPROPRIATE MONUMENTATION BY A LICENSED LAND SURVEYOR OR A REGISTERED CIVIL ENGINEER AUTHORIZED TO PRACTICE LAND SURVEYING. A CORNER RECORD OF RECORD OF SURVEY, AS APPROPRIATE, SHALL BE FILED BY THE LICENSED LAND SURVEYOR OR REGISTERED CIVIL ENGINEER AS REQUIRED BY THE LAND SURVEYOR'S ACT.
- 8. MINIMUM 90% COMPACTION IS REQUIRED IN ALL ON-SITE FILL AREAS.
- 9. ALL PUBLIC IMPROVEMENTS SHOWN ON THESE IMPROVEMENT PLANS SHALL BE CONSTRUCTED TO THE SATISFACTION OF THE CITY ENGINEER PRIOR TO ACCEPTANCE BY THE CITY.
- 10. ALL OPERATIONS CONDUCTED ON THE PROJECT SITE, INCLUDING THE WARMING UP, REPAIR, ARRIVAL, DEPARTURE OR RUNNING OF ANY EQUIPMENT SHALL BE LIMITED TO THE HOURS OF 8:00 A.M. TO 5:00 P.M. OR AS APPROVED, SUNDAY THRU THURSDAY, NO WORK SHALL BE PERFORMED ON FRIDAY, SATURDAY OR HOLIDAYS.
- 11. ALL TRENCH EXCAVATION AND BACKFILL IN THE PUBLIC RIGHT-OF-WAY SHALL CONFORM TO THE REQUIREMENTS OF THE CITY'S EXCAVATION ORDINANCE.
- 12. THE CONTRACTOR AND IT'S SUBCONTRACTORS SHALL COMPLY WITH GENERAL ENGINEERING STANDARDS AND THE PROJECT STANDARDS AND SPECIFICATIONS.
- 13. THE CONTRACTOR SHALL BE RESPONSIBLE FOR THE INSTALLATION, RELOCATION OR REPLACEMENT OF ALL STRIPING, SIGNING OR TRAFFIC DETECTOR LOOPS AS REQUIRED AND/OR AS SHOWN ON THE
- 14. DUST CONTROL MEASURES, SUCH AS THE PERIODIC WETTING DOWN OF THE BARE AND EXPOSED AREAS, SHALL BE UTILIZED AT ALL TIMES DURING CONSTRUCTION.
- 15. THE CONTRACTOR IS RESPONSIBLE FOR MAINTAINING THE ADJOINING PUBLIC STREETS AND RIGHTS-OF-WAY IN A CLEAN AND DUST FREE CONDITION WITHIN THE REQUIREMENTS OF THE CITY MUNICIPAL CODE SECTION 26.150000 "ILLICIT DISCHARGES PROHIBITED." THIS SECTION OF THE CODE PROHIBITS THE "WASHING DOWN" OF A STREET INTO A PUBLIC STORM DRAIN. THE REGULAR USE OF STREET SWEEPING MACHINES MAY BE REQUIRED.
- THE CONTRACTOR IS SOLELY RESPONSIBLE FOR CONSTRUCTION OPERATIONS OF THIS PROJECT.
- 17. A PERMIT MUST BE OBTAINED FROM THE SAN MARCOS FIRE DEPARTMENT PRIOR TO ANY BLASTING. CITY PERMITS ARE REQUIRED PRIOR TO ANY STORAGE OF HAZARDOUS MATERIALS OR ANY OTHER ENCROACHMENTS.
- 18. THE CONTRACTOR SHALL ASSUME SOLE AND COMPLETE RESPONSIBILITY FOR JOB SITE CONDITIONS DURING THE COURSE OF CONSTRUCTION OF THIS PROJECT, INCLUDING SAFETY OF ALL PERSONS AND PROPERTY. THIS REQUIREMENT SHALL APPLY CONTINUALLY AND NOT BE LIMITED TO NORMAL WORKING HOURS. THE CONTRACTOR SHALL DEFEND, INDEMNITY AND HOLD THE OWNER. THE ENGINEER, THE CITY, AND ITS AGENTS HARMLESS FROM ANY AND ALL LIABILITY, REAL OR ALLEGED, IN CONNECTION WITH THE PERFORMANCE OF WORK ON THIS PROJECT EXCEPTING FOR LIABILITY ARISING FROM THE SOLE NEGLIGENCE OF THE OWNER, ENGINEER OR CITY.
- 19. EROSION CONTROL. INCLUDING RIP-RAP, INTERIM SLOPE PROTECTION, SANDBAGS OR OTHER EROSION CONTROL MEASURES SHALL BE PROVIDED TO CONTAIN SEDIMENT AND SILT WITHIN THE PROJECT. THE CONTRACTOR SHALL BE SOLELY RESPONSIBLE FOR MAINTAINING ALL EROSION CONTROL FACILITIES THROUGHOUT THE DEVELOPMENT OF THE PROJECT IN ACCORDANCE WITH THE PROJECT'S STORM WATER POLLUTION PREVENTION PLAN (SWPPP) AND SOIL EROSION CONTROL PLANS. THE CONTRACTOR SHALL REIMBURSE THE CITY FOR ANY PENALTIES OR FINES LEVIED AGAINST IT AS A RESULT OF NON-COMPLIANCE WITH THE PROJECT SWPPP.

SAN MARCOS FIRE DEPARTMENT

3-29-21

V.W.D. AS-BUILT NO. 60755 ****★\Exp. 12-31-22/★ R.C.E. No. ____ ___ EXP. _ VALLECITOS WATER DISTRIC ENGINEER OF WORK

Name: JOSH C. STONE

R.C.F. C60755

_exp: 12/31/22

No. Description

5050 Avenida Encinas Suite 260 Carlsbad, CA 92008 Phone: (760) 476-9193 INTERNATIONAL MBAKERINTL.COM

_exp.: 12/31/2022 R.C.E.: 76583

CITY OF SAN MARCOS

IMPROVEMENT PLANS FOR SAN MARCOS BOULEVARD AT DISCOVERY STREET INTERSECTION CIP No. 86002

IMPROVEMENT NOTES (CONT.)

- TRAFFIC CONTROL PLANS, INCLUDING THE LAYOUT OF THE CONSTRUCTION WARNING AND DETAIL SIGNS, SHALL BE SUBMITTED FOR APPROVAL A MINIMUM OF 10 WORKING DAYS PRIOR TO THE COMMENCEMENT OF CONSTRUCTION. TRAFFIC CONTROL SHALL BE IMPLEMENTED BEFORE ANY WORK IS STARTED.
- THE CONTRACTOR SHALL CONFINE OPERATIONS TO THE AREAS SHOWN UNLESS SPECIAL ARRANGEMENTS ARE OTHERWISE MADE WITH INDIVIDUAL PROPERTY OWNERS. THE CONTRACTOR SHALL CONDUCT OPERATIONS IN ACCORDANCE WITH ANY OTHER PROVISIONS AND SHALL OBSERVE ANY RESTRICTIONS AS DIRECTED BY THE AGENCY'S AUTHORIZED REPRESENTATIVE CONCERNING WORK ON PRIVATE PROPERTY. THE CONTRACTOR SHALL PROVIDE THE CITY WITH ANY AGREEMENTS WITH PRIVATE INDIVIDUALS FOR USE OF THEIR PROPERTY.
- 22. IMPORTED MATERIAL SHALL BE OBTAINED FROM A LEGAL SITE. EXPORTED MATERIAL SHALL BE DELIVERED TO A LEGAL SITE.
- 23. NOTWITHSTANDING THE MINIMUM STANDARDS SET FORTH IN THE CITY'S GRADING ORDINANCE AND THE APPROVAL OF THESE PLANS, THE CONTRACTOR IS RESPONSIBLE FOR THE PREVENTION OF DAMAGE TO ADJACENT PROPERTY. NO PERSON SHALL EXCAVATE ON LAND SO CLOSE TO THE PROPERTY LINE SO AS TO ENDANGER ANY SYSTEM. OR ANY OTHER PUBLIC OR PRIVATE PROPERTY WITHOUT SUPPORTING AND PROTECTING SUCH PROPERTY FROM SETTLING. CRACKING, EROSION, SILTING, SCOUR OR OTHER DAMAGE WHICH MIGHT RESULT FROM THE WORK DESCRIBED ON THIS PLAN. THE CITY WILL HOLD THE CONTRACTOR RESPONSIBLE FOR CORRECTION OF WORK, WHICH CAUSES DAMAGE TO ADJACENT PROPERTY.
- ALL DEBRIS CREATED BY LANDSCAPE CONSTRUCTION OPERATIONS SHALL BECOME THE PROPERTY OF THE CONTRACTOR UNLESS OTHERWISE NOTED AND SHALL BE DISPOSED OFF THE JOB SITE DAILY IN A MANNER ACCEPTABLE TO THE OWNER.

GEOTECHNICAL ENGINEER CERTIFICATE

THESE PLANS HAVE BEEN REVIEWED BY THE UNDERSIGNED RELATIVE TO GEOTECHNICAL ASPECTS OF THE PLANS AND HAVE BEEN FOUND TO BE IN CONFORMANCE WITH INTENTIONS OF THE FINDINGS AND RECOMMENDATIONS CONTAINED IN THE GEOTECHNICAL REPORT BY SCST, LLC. BY DANIEL J. RICHARDSON RCE 89379, DATED NOVEMBER/04/2019.

DANIEL J. RICHARDSON RCE 89379 EXP. 12/31/22.



HYDROLOGY/HYDRAULIC REPORT

THE HYDROLOGY/ HYDRAULIC REPORT WAS PREPARED BY MICHAEL BAKER INTERNATIONAL (AUGUST 26, 2020)

DECLARATION OF RESPONSIBLE CHARGE

I HEREBY DECLARE THAT I AM THE ENGINEER OF WORK FOR THIS PROJECT, SHEETS 1 THROUGH 27, THAT I HAVE EXERCISED RESPONSIBLE CHARGE OVER THE DESIGN OF THIS PROJECT AS DEFINED IN SECTION 6703 OF THE BUSINESS AND PROFESSIONS CODE, AND THAT THE DESIGN IS CONSISTENT WITH CURRENT STANDARDS. I UNDERSTAND THAT THE CHECK OF PROJECT DRAWINGS AND SPECIFICATIONS BY THE CITY OF SAN MARCOS IS CONFINED TO A REVIEW ONLY AND DOES NOT RELIEVE ME AS ENGINEER OF WORK OF MY RESPONSIBILITIES FOR THE PROJECT DESIGN. I UNDERSTAND AND ACKNOWLEDGE THAT THE SIGNATURE OF THESE PLANS BY AND THE REVIEW OF THE PLANS BY VALLECITOS WATER DISTRICT IS A REVIEW OF GENERAL COMPLIANCE WITH DISTRICT STANDARDS. THIS APPROVAL IS NOT A DETERMINATION OF THE TECHNICAL ADEQUACY OR ACCURACY OF THE DESIGN OF THE IMPROVEMENTS. SUCH APPROVAL DOES NOT, THEREFORE, RELIEVE ME OF MY RESPONSIBILITY FOR THE DESIGN OF THESE IMPROVEMENTS.

JOSH C. STONE RCE 60755

DATE: 03-03-2021



"AS - BUILT" DECLARATION

AS ENGINEER-OF-WORK, I HEREBY CERTIFY THAT, TO THE BEST OF MY KNOWLEDGE AND BELIEF, THE IMPROVEMENTS SHOWN ON THIS SET OF CONSTRUCTION PLANS, SHEET 1 TO 14, HAVE BEEN INSTALLED AND CONSTRUCTED IN SUBSTANTIAL CONFORMANCE WITH THESE AS-BUILT PLANS, INCLUDING ALL APPROPRIATE STANDARDS AND ANY DISCRETIONARY APPROVAL(S) FOR THE PROJECT

SIGNED DISCIPLINE MY REGISTRATION EXPIRES -

CITY APPROVED CHANGES

Encinas	INSPECTED AND RECOMMENDED FOR ACCEPTANCE	
2008 76-9193 COM	By:	
	RECOMMENDED FOR APPROVAL	APPROVED FOR CONSTRUCTION
App'd By Date	By: Lewis Clapp, Senior Civil Engineer	By: By: I sade Etchamendy : City Engineer


R.C.E. 81294

exp.: 09/30/2021

SHEET INDEX

SHEET NO.

DESCRIPTION PLAN CODE T-1 TITLE SHEET GENERAL NOTES GN-1 TYPICAL CROSS SECTIONS DEMOLITION PLAN DM--1 IMPROVEMENT PLAN AND PROFILE IM-1 TO IM-4 SD-1 T0 SD-3 STORM DRAIN PLAN AND PROFILE CD-1 TO CD-2 CONSTRUCTION DETAILS WATER PLAN AND PROFILE WL.--1 SIGNING AND STRIPING PLAN GENERAL NOTES SS-2 SIGNING AND STRIPING PLAN TRAFFIC SIGNAL PLAN AND NOTES EROSION & SEDIMENT CONTROL PLAN DRAINAGE MANAGEMENT AREA PLAN DMA-1 LDSC-1 TO LDSC-8 LANDSCAPING AND IRRIGATION PLANS CONSTRUCTION DETAILS CD-3 STORM DRAIN PLAN AND PROFILE

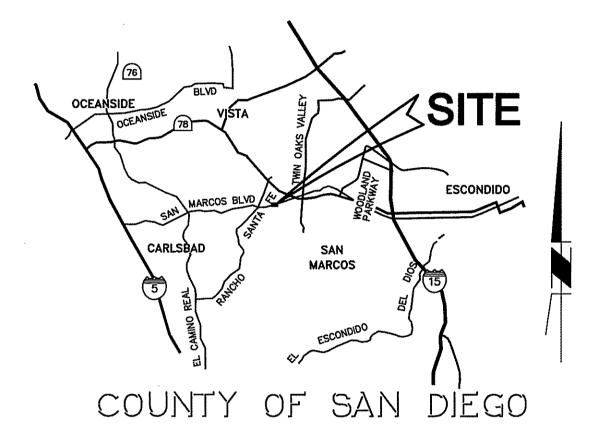

WL-2

VICINITY MAP

VALLEDITOR	MAATED	DIOTRIOT	
VALLECITOS	WAIER	DISTRICT	LEGEND
· · · · · · · · · · · · · · · · · · ·	~ ~ ~ ~ ~ ~ ~ ~ ~		

	OIIOO IIIIII			
TEM	WORK TO BE DONE	QTY/LENGTH	VWD DWG	SYMBOL
KISTING WATER VALVE	ADJUST TO GRADE	2	₩-16	8
KISTING SEWER MANHOLE	ADJUST TO GRADE & RECOME (MATCH EXISTING)	AT LINER 4	S-1	Ś
KTEND EXISTING FIRE HYDRANT	RELOCATE TO NEW R/W	1	₩-4, ₩-5 & ₩	-14 🖂
ELOCATE & EXTEND EXISTING WATER ERVICE AND METER. RE-CERT BF EVICE. (DOMESTIC OR IRRIGATION DICATED ON PLANS)	(RELOCATED EXISTING WATER METER)	4	₩-6, W-7 & W	-19 BF M
KTEND EX. FIRE SERVICE DETECTOR HECK	RELOCATED EXISTING TO N	EW R/W 1/17.0'	W-13	FS
ISTALL 10" PVC CLASS 350 DR-14 TH THRUST BLOCKS	INSTALL	**±185.5'	W-15 & W-16	—— w——
ELOCATE EXISTING 4" METER ABOVE ROUND AND INSTALL NEW BACKFLOW EVICE	INSTALL	1 EA.	W-11 & W-19	⊢ <u>M</u> BF
IP SECTION PIPES	;	67.5 FT. (6" PVC) 32.0 FT. (8" PVC) 41.5 FT. (2" WATER SER	₩-28 ₩-28 /ICE) ₩-28	W
MOVE EXISTING 10" ACP	REMOVE	±163'		
	·	**! S <u>I</u> 1	ENGTH OF SEGME	NT MAY VARY, POINT IS AT

PER CALCULATIONS PREPARED UTILIZING THE NATIONAL GEODETIC SURVEY (NGS) VERTCON (VERTICAL DATUM CONVERSION) TOOL, TO CONVERT ELEVATIONS AT THIS BENCHMARK FROM NAVD 1988 TO NGVD 29, ELEVATION DEPICTED HEREON MUST BE DECREASED BY 2.306 FEET.POINT NUMBER 1021 LISTED BELOW HAS AN ELEVATION OF 510.736

BENCH MARK

Location: PT. NO. 1017: N1992455.016 E6270654.355 PT. NO. 1021: N1992450.992 E6274932.043 Elev.: 513.042 [510.736] Datum: NAVD 1988 NGVD VWD 23

WORK TO BE DONE

CONSTRUCTION.

ITEM

PROPOSED CENTERLINE

THE IMPROVEMENTS CONSIST OF THE FOLLOWING WORK TO BE DONE IN ACCORDANCE WITH THE LATEST EDITION OF THE FOLLOWING DOCUMENTS:

- 1) CITY OF SAN MARCOS STANDARD DRAWINGS AND STANDARD SPECIAL PROVISIONS
- SAN DIEGO AREA REGIONAL STANDARD DRAWINGS STANDARD SPECIFICATIONS FOR PUBLIC WORKS CONSTRUCTION ("GREEN BOOK"-2015)
- CITY OF SAN MARCOS GRADING AND EXCAVATION ORDINANCE
- CITY OF SAN MARCOS TRAFFIC SIGNAL MANUAL FOR NEW SIGNAL DESIGNS AND INSTALLATIONS
- STATE OF CALIFORNIA DEPARTMENT OF TRANSPORTATION (CALTRANS) STANDARDS PLANS
- STATE OF CALIFORNIA DEPARTMENT OF TRANSPORTATION (CALTRANS) STANDARD SPECIFICATIONS 10) MANUAL ON UNIFORM TRAFFIC CONTROL DEVICES (MUTCD)
- 11) STATE OF CALIFORNIA DEPARTMENT OF TRANSPORTATION SUPPLEMENTAL TO MUTCO 12) VALLECITOS WATER DISTRICT STANDARD DRAWINGS AND SPECIFICATIONS, DESIGN CRITERIA AND
- APPROVED MATERIALS LIST
- 13) CITY OF SAN MARCOS IRRIGATION AND LANDSCAPE APPROVED MATERIALS LIST
- 14) CITY OF SAN MARCOS IRRIGATION AND LANDSCAPE STANDARD DRAWINGS ANY CHANGES OR REVISIONS THEREFROM SHALL BE APPROVED BY THE CITY ENGINEER OR VWD PRIOR TO

LEGEND

STANDARD DRAWING

SYMBOL

0

C

PROPOSED CENTERLINE		<u> </u>
*PROPOSED PAVING. SECTION PER PLAN		
*PROPOSED PAVING. SECTION PER PLAN		
PROPOSED 2"AC GRIND AND OVERLAY		
PROPOSED SLURRY SEAL		
PROPOSED MONOLITHIC SIDEWALK	SDRSD G-7,	
PROPOSED 6" TYPE 'G' CURB AND GUTTER	G-9,G10,G-11 SDRSD G-2	
PROPOSED 6" CURB	SDRSD G-1	
PROPOSED 6" MEDIAN CURB	SDRSD G-6	
CONCRETE PED. RAMP WITH RAISED TRUNCATED DOMES (DARK GRAY)	SDRSD G-27 & G-30	
TYPE 'B-1' CURB INLET	SDRS D-2	
SIDEWALK UNDER DRAIN OUTLET PROPOSED STORM DRAIN PIPE (RCP)	SDRS D-25	
PROPOSED STORM DRAIN CLEANOUT TYPE A-4&5	SDRSD D-9	
PROPOSED CATCH BASIN TYPE F	SDRSD D-7	
PROPOSED CATCH BASIN TYPE G-2	SDRSD D-8	
PROPOSED 6" PVC PIPE		
PROPOSED PVC PIPE CLEANOUT		0
PROPOSED HANDRAIL		-000
INSTALL CONCRETE COLLAR	SDRSD D-62	
PROPOSED RIP RAP ENERGY DISSIPATOR	SDRSD D-40	
PROPOSED CROSS GUTTER	SDRSD G-12	
PROPOSED RETAINING WALL	SDRSD C-09 & C-10	
PROPOSED CONTOUR		212
EXISTING CONTOUR		(212)
PROPOSED LIGHT		Q
LIMITS OF WORK/DAYLIGHT LINE		
EXISTING PROPERTY LINE		
EXISTING RIGHT OF WAY LINE EXISTING CURB AND GUTTER		
EXISTING CORB AND GOTTER EXISTING EDGE OF PAVEMENT		11-14-11-11-11-22-11-14-5-11-14-14-1-1-14-1-1-1-1-1-1-1-1
EXISTING WALL		Control of the Contro
EXISTING FENCE		mana of the management of management of the mana
EXISTING WATER (PROTECT IN PLACE)		
EXISTING SEWER (PROTECT IN PLACE)		——————————————————————————————————————
EXISTING STORM DRAIN (SIZE/MATERIAL AS INC	·	SD
EXISTING H.P. GAS (SIZE/MATERIAL AS INDICA	•	
EXISTING SEWER FORCE MAIN (PROTECT IN PLACE	•	——————————————————————————————————————
EXISTING TELECOMMUNICATIONS LINE (OWNER AS	•	—— —— —— —— —— —— —— —— —— —— —— —— ——
EXISTING H.P. GAS (SIZE/MATERIAL AS INDICATION EXISTING ELECTRICAL	ATED UN PLAN)	— G — —
EXISTING ELECTRICAL EXISTING GAS VALVE		
EXISTING STORM DRAIN CLEANOUT		© 0
SAWCUT		
COMMERCIAL CONCRETE DRIVEWAY		R/
POINT OF BEGINNING		(P.O.B.)
DETAIL NO.		C
SHEET NO		

PLAN CODE

(FC-3)

VWD W.O. 207141

CITY OF SAN MARCOS ENGINEERING DIVISION Description: CITY OF SAN MARCOS GPS PT. NO. 1017 AND TITLE SHEET FOR GPS PT. NO. 1021 PER ROS 13928 SAN MARCOS BOULEVARD AT DISCOVERY STREET INTERSECTION

*PAVEMENT SECTION TO BE CONFIRMED AND

APPROVED BY ENGINEER PRIOR TO INSTALLATION

SHEET NO.

City Drawing No. P18-00009 Sheet 1 of 29


ABBREVIATIONS D.S. DOWN SPOUT L.O.W. LIMIT OF WORK SANITARY SEWER DRAWING ASPHALT CONCRETE MCV MASTER CONTROL VALVE STREET ADD ADDITIVE ELECTRICAL METER VAULT MTN MINIMUM STD STANDARD ADJ END CURVE ADJACENT N.I.C. NOT IN CONTRACT SIDEWALK EJ EXPANSION JOINT ALT ALTERNATE PLANTING AREA TOP OF BERM EDGE OF PAVEMENT ACCESSOR'S PARCEL NUMBER POINT OF COMPOUND CURVE TOP OF CURB EQ EQUAL **AVENUE** PCR POINT OF CURB RETURN TRAFFIC SIGNAL END VERTICAL CURVE EVC BEGIN CURVE P.O.C. POINT OF CURVATURE TOP OF WALL BUILDING ΕX EXISTING PP POWER POLE TYP. TYPICAL B.O.C. BACK OF CURB FIRE ALARM PAVEMENT U.O.N. BEGIN VERTICAL CURVE FINISH GRADE RET RETAINING ULTRA-VIOLET U.V. BOTTOM OF WALL FLOWLINE REINFORCED CONCRETE PIPE F.O.B. FACE OF BLDG CATV CABLE TELEVISION REMOTE CONTROL VALVE WATER LINE F.O.C. FACE OF CURB CURB & GUTTER RADIUS GALLONS CORRUGATED MATAL PIPE RIM RIM ELEVATION CLEANOUT GRADE BREAK R.O.W. RIGHT OF WAY CO GALLONS PER MINUTE SLUMP BLOCK COL. COLUMN SB CONC CONCRETE GAS VALVE SC0 SEWER CLEANOUT HIGH DENSITY POLYETHYLENE SD COND. CONDITIONS STORM DRAIN CSM CITY OF SAN MARCOS HIGH POINT SDG&E SAN DIEGO GAS & ELECTRIC HP GAS HIGH PRESSURE GAS LINE DEG DEGREE SDRSD SAN DIEGO REGIONAL STANDARD DRAWING INVERT ELEVATION DF DRINKING FOUNTAIN SIM SIMILAR IRRIGATION SMCWD SAN MARCOS COUNTY WATER DISTRICT DECOMPOSED GRANITE LINEAL FEET SEWER MANHOLE DIMENSION DRAIN OUTLET/UNDER WALK DRAIN PIPE


TRIBAL CULTURAL RESOURCE NOTES


- 1. THE QUALIFIED ARCHAEOLOGIST SHALL MAINTAIN ONGOING COLLABORATIVE CONSULTATION WITH THE TCA NATIVE AMERICAN MONITOR DURING ALL GROUND DISTURBING ACTIVITIESTHE APPLICANT/OWNER OR GRADING CONTRACTOR SHALL NOTIFY THE PLANNING DIVISION, PREFERABLY THROUGH E-MAIL, OF THE START AND END OF ALL GROUND DISTURBING ACTIVITIES.
- 2. THE QUALIFIED ARCHAEOLOGIST AND TCA NATIVE AMERICAN MONITOR SHALL ATTEND ALL APPLICABLE PRE-CONSTRUCTION MEETINGS WITH THE GENERAL CONTRACTOR AND/OR ASSOCIATED SUBCONTRACTORS TO PRESENT THE ARCHAEOLOGICAL MONITORING PROGRAM. THE QUALIFIED ARCHAEOLOGIST AND TCA NATIVE AMERICAN MONITOR SHALL BE PRESENT ON-SITE FULL-TIME DURING GRUBBING, GRADING AND/OR OTHER GROUND DISTURBING ACTIVITIES, INCLUDING THE PLACEMENT OF IMPORTED FILL MATERIALS OR FILL USED FROM OTHER AREAS OF THE PROJECT SITE, TO IDENTIFY ANY EVIDENCE OF POTENTIAL ARCHAEOLOGICAL OR CULTURAL RESOURCES. ALL FILL MATERIALS SHALL BE ABSENT OF ANY AND ALL CULTURAL RESOURCES. THE APPLICANT/OWNER OR GRADING CONTRACTOR MAY SUBMIT WRITTEN DOCUMENTATION TO THE CITY TO SUBSTANTIATE IF ANY FILL MATERIAL IS ABSENT OF CULTURAL RESOURCES. SHOULD THE CITY CONCUR THAT THE FILL MATERIAL IS ABSENT OF CULTURAL RESOURCES. IN CONSULTATION WITH A QUALIFIED ARCHAEOLOGIST AND/OR THE TCA NATIVE AMERICAN MONITOR, THEN NO MONITORING OF THAT FILL MATERIAL IS REQUIRED


SPILL NOTIFICATION: 760-481-3878 OR 911 (AFTER HOURS) 3. THE QUALIFIED ARCHAEOLOGIST OR THE TCA NATIVE AMERICAN MONITOR MAY HALT GROUND DISTURBING MAINTENANCE AGREEMENT DOCUMENT #: NOT APPLICABLE ACTIVITIES IF UNKNOWN ARCHAEOLOGICAL ARTIFACT DEPOSITS OR CULTURAL FEATURES ARE DISCOVERED. GROUND DISTURBING ACTIVITIES SHALL BE DIRECTED AWAY FROM THESE DEPOSITS TO ALLOW A DETERMINATION OF POTENTIAL IMPORTANCE. ISOLATES AND CLEARLY NON-SIGNIFICANT DEPOSITS (AS DETERMINED BY THE QUALIFIED ARCHAEOLOGIST, IN CONSULTATION WITH THE TCA NATIVE AMERICAN MONITOR) WILL BE MINIMALLY DOCUMENTED IN THE FIELD, COLLECTED AND BE GIVEN TO THE TCA TRIBE SO THAT THEY MAY BE REBURIED AT THE SITE ON A LATER DATE. IF A DETERMINATION IS MADE THAT THE UNEARTHED ARTIFACT DEPOSITS OR TRIBAL CULTURAL RESOURCES ARE CONSIDERED POTENTIALLY SIGNIFICANT, THE TCA TRIBE SHALL BE NOTIFIED AND CONSULTED WITH IN REGARDS TO THE RESPECTFUL AND DIGNIFIED TREATMENT OF THOSE RESOURCES. ALL SACRED SITES, SIGNIFICANT TRIBAL CULTURAL RESOURCES AND/OR UNIQUE ARCHAEOLOGICAL RESOURCES ENCOUNTERED WITHIN THE HOWEVER, A DATA RECOVERY PLAN IS AUTHORIZED BY THE CITY AS THE LEAD AGENCY UNDER CEQA, THE CONTRACTED TCA TRIBE SHALL BE NOTIFIED AND CONSULTED REGARDING THE DRAFTING AND SAN MARCOS BLVD FINALIZATION OF ANY SUCH RECOVERY PLAN. FOR SIGNIFICANT ARTIFACT DEPOSITS, TRIBAL CULTURAL RESOURCES OR CULTURAL FEATURES THAT ARE PART OF A DATA RECOVERY PLAN. AN ADEQUATE ARTIFACT SAMPLE TO ADDRESS RESEARCH AVENUES PREVIOUSLY IDENTIFIED FOR SITES IN THE AREA WILL BE COLLECTED USING PROFESSIONAL ARCHAEOLOGICAL COLLECTION METHODS. IF THE QUALIFIED ARCHAEOLOGIST COLLECTS SUCH RESOURCES, THE TCA NATIVE AMERICAN MONITOR MUST BE PRESENT DURING ANY TESTING OR CATALOGING OF THOSE RESOURCES. MOREOVER, IF THE QUALIFIED SPECIAL FLOOD HAZARD AREA \$ 10 (4) 12 (6) ARCHAEOLOGIST DOES NOT COLLECT THE CULTURAL RESOURCES THAT ARE UNEARTHED DURING THE GROUND DISTURBING ACTIVITIES, THE TCA NATIVE AMERICAN MONITOR. MAY AT THEIR DISCRETION, COLLECT SAID RESOURCES AND PROVIDE THEM TO THE CONTRACTED TCA TRIBE FOR RESPECTFUL AND DIGNIFIED TREATMENT IN ACCORDANCE WITH THE TRIBE'S CULTURAL AND SPIRITUAL TRADITIONS. IF THE DEVELOPER, THE QUALIFIED ARCHAEOLOGIST AND THE TCA TRIBE CANNOT AGREE ON THE SIGNIFICANCE OR MITIGATION FOR SUCH RESOURCES, THESE ISSUES WILL BE PRESENTED TO THE PLANNING DIVISION MANAGER FOR DECISION. THE PLANNING DIVISION MANAGER SHALL MAKE A DETERMINATION BASED UPON THE PROVISIONS OF THE CALIFORNIA ENVIRONMENTAL QUALITY ACT AND CALIFORNIA PUBLIC RESOURCES CODE SECTION 21083.2(B) WITH RESPECT TO ARCHAEOLOGICAL RESOURCES, TRIBAL CULTURAL RESOURCES AND SHALL TAKE INTO ACCOUNT THE RELIGIOUS BELIEFS, CULTURAL BELIEFS, CUSTOMS AND PRACTICES OF THE TCA TRIBE. NOTWITHSTANDING ANY OTHER RIGHTS AVAILABLE UNDER LAW, THE DECISION OF THE PLANNING DIVISION MANAGER SHALL BE APPEALABLE TO THE PLANNING COMMISSION AND/OR CITY COUNCIL. AS SPECIFIED BY CALIFORNIA HEALTH AND SAFETY CODE SECTION 7050.5, IF HUMAN REMAINS ARE FOUND ON THE PROJECT SITE DURING CONSTRUCTION OR DURING ARCHAEOLOGICAL WORK, THE PERSON RESPONSIBLE FOR THE EXCAVATION, OR HIS OR HER AUTHORIZED REPRESENTATIVE, SHALL IMMEDIATELY NOTIFY THE SAN DIEGO COUNTY MEDICAL EXAMINER'S OFFICE. NO FURTHER EXCAVATION OR DISTURBANCE OF THE SITE OR ANY NEARBY AREA REASONABLY SUSPECTED TO OVERLIE ADJACENT **KEY MAP LEGEND** REMAINS SHALL OCCUR UNTIL THE MEDICAL EXAMINER HAS MADE THE NECESSARY FINDINGS AS TO ORIGIN AND DISPOSITION PURSUANT TO PUBLIC RESOURCES CODE 5097.98. IF SUCH A DISCOVERY OCCURS, A TEMPORARY CONSTRUCTION EXCLUSION ZONE SHALL BE ESTABLISHED SURROUNDING THE AREA IMPROVEMENT PLAN SHEET NUMBER OF THE DISCOVERY SO THAT THE AREA WOULD BE PROTECTED, AND CONSULTATION AND TREATMENT COULD OCCUR AS PRESCRIBED BY LAW. BY LAW, THE MEDICAL EXAMINER WILL DETERMINE WITHIN TWO STORM DRAIN IMPROVEMENT PLAN SHEET NUMBER WORKING DAYS OF BEING NOTIFIED IF THE REMAINS ARE SUBJECT TO HIS OR HER AUTHORITY. IF THE MEDICAL EXAMINER RECOGNIZES THE REMAINS TO BE NATIVE AMERICAN, HE OR SHE SHALL CONTACT THE TRAFFIC SIGNAL PLAN NATIVE AMERICAN HERITAGE COMMISSION (NAHC), BY TELEPHONE, WITHIN 24 HOURS. THE NAHC WILL MAKE A DETERMINATION AS TO THE MOST LIKELY DESCENDENT. IF SUSPECTED NATIVE AMERICAN REMAINS ARE DISCOVERED, THE REMAINS SHALL BE KEPT IN-SITU, OR IN A SECURE LOCATION IN SPECIAL FLOOD HAZARD AREA CLOSE PROXIMITY TO WHERE THEY WERE FOUND, AND THE EXAMINATION OF THE REMAINS SHALL ONLY OCCUR ON-SITE IN THE PRESENCE OF A TCA NATIVE AMERICAN MONITOR. **KEY MAP** v.w.d. as—built INSPECTED AND RECOMMENDED Michael Baker FOR ACCEPTANCE 1"=80' Carlsbad, CA 92008 GN-1Phone: (760) 476-9193 INTERNATIONAL MBAKERINTL.COM Public Works Inspector SCALE: 1"=80' VWD W.O. 207141 SAN MARCOS FIRE DEPARTMENT VALLECITOS WATER DISTRICT ENGINEER OF WORK CITY APPROVED CHANGES RECOMMENDED FOR APPROVAL APPROVED FOR CONSTRUCTION CITY OF SAN MARCOS ENGINEERING DIVISION **BENCH MARK** App'd By Date No. Description Description: CITY OF SAN MARCOS GPS PT. NO. 1017 AND GENERAL NOTES FOR: GPS PT. NO. 1021 PER ROS 13928 y. Twill JASON NAILON, FIRE MARSHA SAN MARCOS BOULEVARD AT DISCOVERY IP18-00009 Name: JOSH C. STONE Lewis Clapp, Senior Civil Engineer R.C.E. 81294 exp.: 09/30/2021 Location: <u>PT. NO. 1017: N1992455.016 E6270654.355 PT. NO. 1021: N1992450.992 E6274932.043 Elev.: 513.042 [510.736] Datum: NAVD 1988 [NGVD VWD 29]</u> exp.: 12/31/2022 R.C.E.: C60755 __exp: 12/31/22 STREET INTERSECTION Date: 6/28/21 Sheet 2 of 29

BASIS OF COORDINATES & BEARINGS VALLECITOS WATER DISTRICT GENERAL NOTES (CITY) THE COORDINATES AND BEARINGS SHOWN HEREON ARE BASED UPON THE CALIFORNIA COORDINATE SYSTEM OF 1. ALL WATER AND SEWER LINES SHALL BE CONSTRUCTED ACCORDING TO THE CONTRACT DOCUMENTS AND CURRENT STANDARD 1983, CCS83, ZONE 6, (EPOCH NOT STATED). SAID COORDINATES AND BEARINGS ARE BASED LOCALLY UPON SPECIFICATIONS, DRAWINGS AND APPROVED MATERIAL LIST OF THE VALLECITOS WATER DISTRICT. FIELD-OBSERVED TIES TO THE FOLLOWING CONTROL STATIONS PER RECORD OF SURVEY 13928 (CITY OF SAN MARCOS SURVEY CONTROL). 2. A MINIMUM OF ONE FOOT VERTICAL CLEARANCE IS REQUIRED AT ALL CROSSINGS OF DISTRICT FACILITIES WITH OTHER UTILITIES UNLESS APPROVED BY THE DISTRICT PRIOR TO CONSTRUCTION. STATION GRID NORTHING (FT.) GRID NORTHING (FT.) <u>1017 | 199245</u>5.016 | 6270654.335 3. CONTRACTOR SHALL POTHOLE (EXCAVATE AND EXPOSE) ALL UTILITIES ALONG CONSTRUCTION EXCAVATION CORRIDOR AS SHOWN 1021 | 1992450.992 6274932.043 ON PLANS OR IDENTIFIED BY USA MARK-OUT. THE POTHOLE INFORMATION (UTILITY SIZE, TYPE, LOCATION, ELEVATION, GRADE AND ALIGNMENT) SHALL BE SUBMITTED TO VALLECITOS WATER DISTRICT PRIOR TO CONSTRUCTION. IN ADDITION. UNLESS OTHERWISE NOTED POTENTIAL CONFLICTS WITH EXISTING UTILITIES, AS IDENTIFIED BY CONTRACTOR, SHALL BE SUBMITTED PRIOR TO DISTANCES SHOWN HEREON ARE GROUND AND IN TERMS OF THE U.S. SURVEY FOOT. CONTROL POINT 300: GRID DISTANCE = GROUND DISTANCE X COMBINED SCALE FACTOR (0.99994091) CONSTRUCTION. CONSEQUENCES OF CONTRACTOR'S FAILURE TO POTHOLE AND PROVIDE INFORMATION TO DISTRICT SHALL BE VALLECITOS WATER DISTRIC THE CONTRACTOR'S FULL RESPONSIBILITY AND LIABILITY. DATE OF SURVEY 4. THE CONTRACTOR SHALL BE SOLELY RESPONSIBLE FOR THE ENFORCEMENT OF SAFETY STANDARDS. NOVEMBER 13, 2017 5. A PRECONSTRUCTION CONFERENCE MEETING WITH VALLECITOS WATER DISTRICT PERSONNEL SHALL BE HELD A MINIMUM OF THREE **BENCH MARK** (3) WORKING DAYS PRIOR TO CONSTRUCTION. INSPECTION OF ALL WORK IS REQUIRED. FORTY-EIGHT (48) HOURS ADVANCE NOTICE IS REQUIRED FOR INSPECTION. THE BASIS OF ELEVATIONS FOR THIS SURVEY IS THE NORTH AMERICAN VERTICAL DATUM OF 1988 (NAVD88) PER RECORD OF SURVEY 13928 (CITY OF SAN MARCOS SURVEY CONTROL). BENCHMARK DESIGNATION: 6. ANY PROPOSED CHANGES IN THE APPROVED IMPROVEMENT PLANS MUST BE REVIEWED AND APPROVED BY THE DISTRICT PRIOR TO CONTROL POINT NUMBER 1017. 3" COUNTY BRASS DISC, STAMPED "S.D. CO. ENGINEER DEPT SURVEY THE INSTALLATION OF SUCH CHANGES AND THE CHANGES SHALL BE SHOWN ON THE IMPROVEMENT PLANS. MONUMENT ES 385, WITH SMALL RAISED EXTRUSION, INSTEAD OF PUNCH. **ELEVATION: 513.042 (NAVD88)** 7. IT SHALL BE THE RESPONSIBILITY OF THE CONTRACTOR TO MAINTAIN AT ALL TIMES ON THE JOB SITE. AN "AS-BUILT" LOW POINT SQ RECORD OF ALL WATER AND SEWER MAINS AND APPURTENANCES INSTALLED UNDER THIS CONTRACT. SQUARE **REFERENCE DRAWINGS** 8. A BLASTING PLAN SHALL BE SUBMITTED FOR DISTRICT APPROVAL PRIOR TO THE USE OF EXPLOSIVES NEAR DISTRICT CITY DWG NO. IP-4647 FACILITIES. SAN MARCOS COUNTY WATER DISTRICT DWG. NO. 2534 9. THE CONTRACTOR SHALL BE RESPONSIBLE FOR REMOVAL OF ACP PIPE WHICH SHALL BE PREFORMED BY A CONTRACTOR SAN MARCOS COUNTY WATER DISTRICT DWG. NO. 5484H-1 REGISTERED BY CAL/OSHA AND CERTIFIED BY THE STATE CONTRACTORS LICENSING BOARD FOR ASBESTOS REMOVAL. SAN MARCOS COUNTY WATER DISTRICT DWG. NO. B-173 SAN MARCOS COUNTY WATER DISTRICT DWG. NO. 1304-05 10. UPON CONNECTION OF THE NEW WATER SYSTEM TO THE EXISTING SYSTEM, ALL VALVES ON THE EXISTING AND NEW SYSTEM SHALL BE OPERATED ONLY BY DISTRICT PERSONNEL. SHUTDOWNS SHALL BE REQUESTED, IN WRITING, A MINIMUM OF 6 STORM WATER PERMIT SUMMARY WORKING DAYS IN ADVANCE. ALL SHUTDOWNS REQUIRE STATE CERTIFIED BACTERIA TESTING PRIOR TO REACTIVATION. WATERSHED NAME/HSA #: RICHLAND 904.52, CARLSBAD HYDRAULIC UNIT (HU), SAN MARCOS HYDROLOGIC AREA (HA). RICHLAND HYDROLOGIC SUBAREA (HSA) BMP DESIGN MANUAL STATUS: PRIORITY PRIORITY FACILITY TYPE: BIOFILTRATION BASIN AND PROPRIETARY BIOFILTRATION (FILTERRA) BMP ID #S ASSIGNED: TBD GENERAL CONSTRUCTION PERMIT WDID #: TBD TTWQ: HIGH GENERAL INDUSTRIAL PERMIT WDID #: NOT APPLICABLE WATER DISCHARGE PERMIT: NONE DISCHARGES TO CITY STORM DRAIN SYSTEM DURING CONSTRUCTION OR OPERATION OF THE FACILITY ARE STRICTLY PROHIBITED PER SMC 14.15 AND SDRWQCB PERMIT R9-2007-001 **PLAN CODE** City Drawing No.

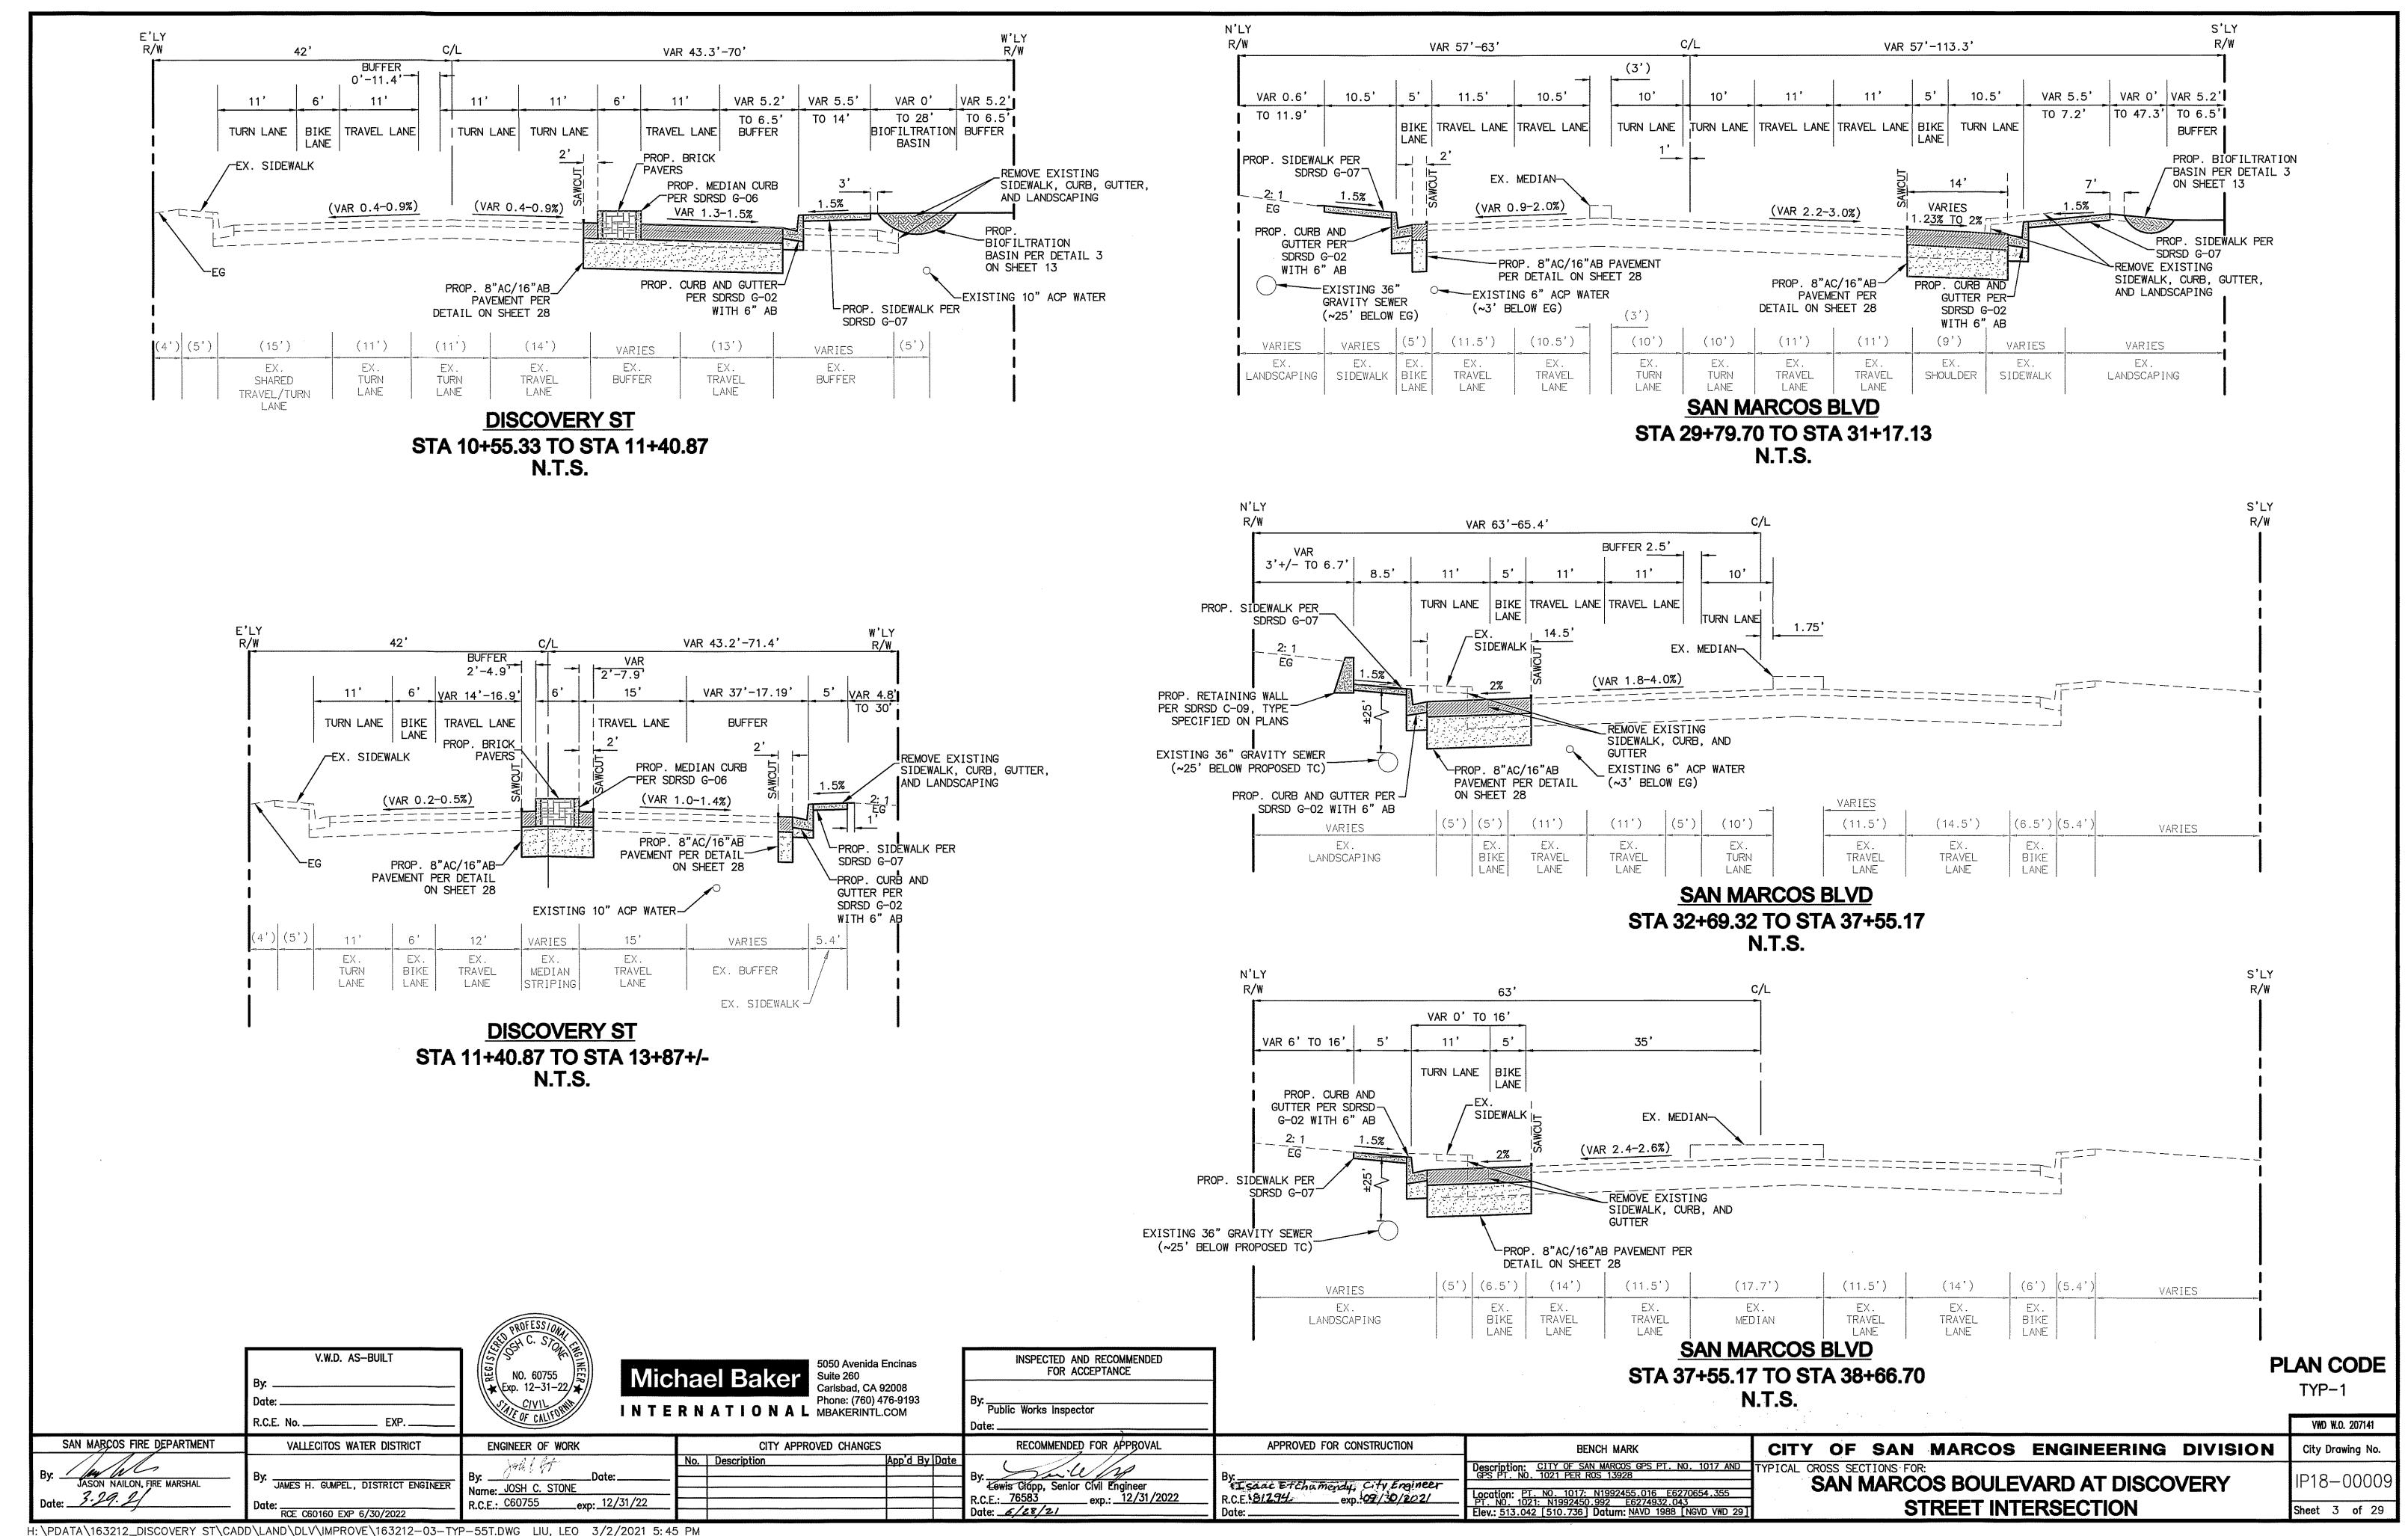

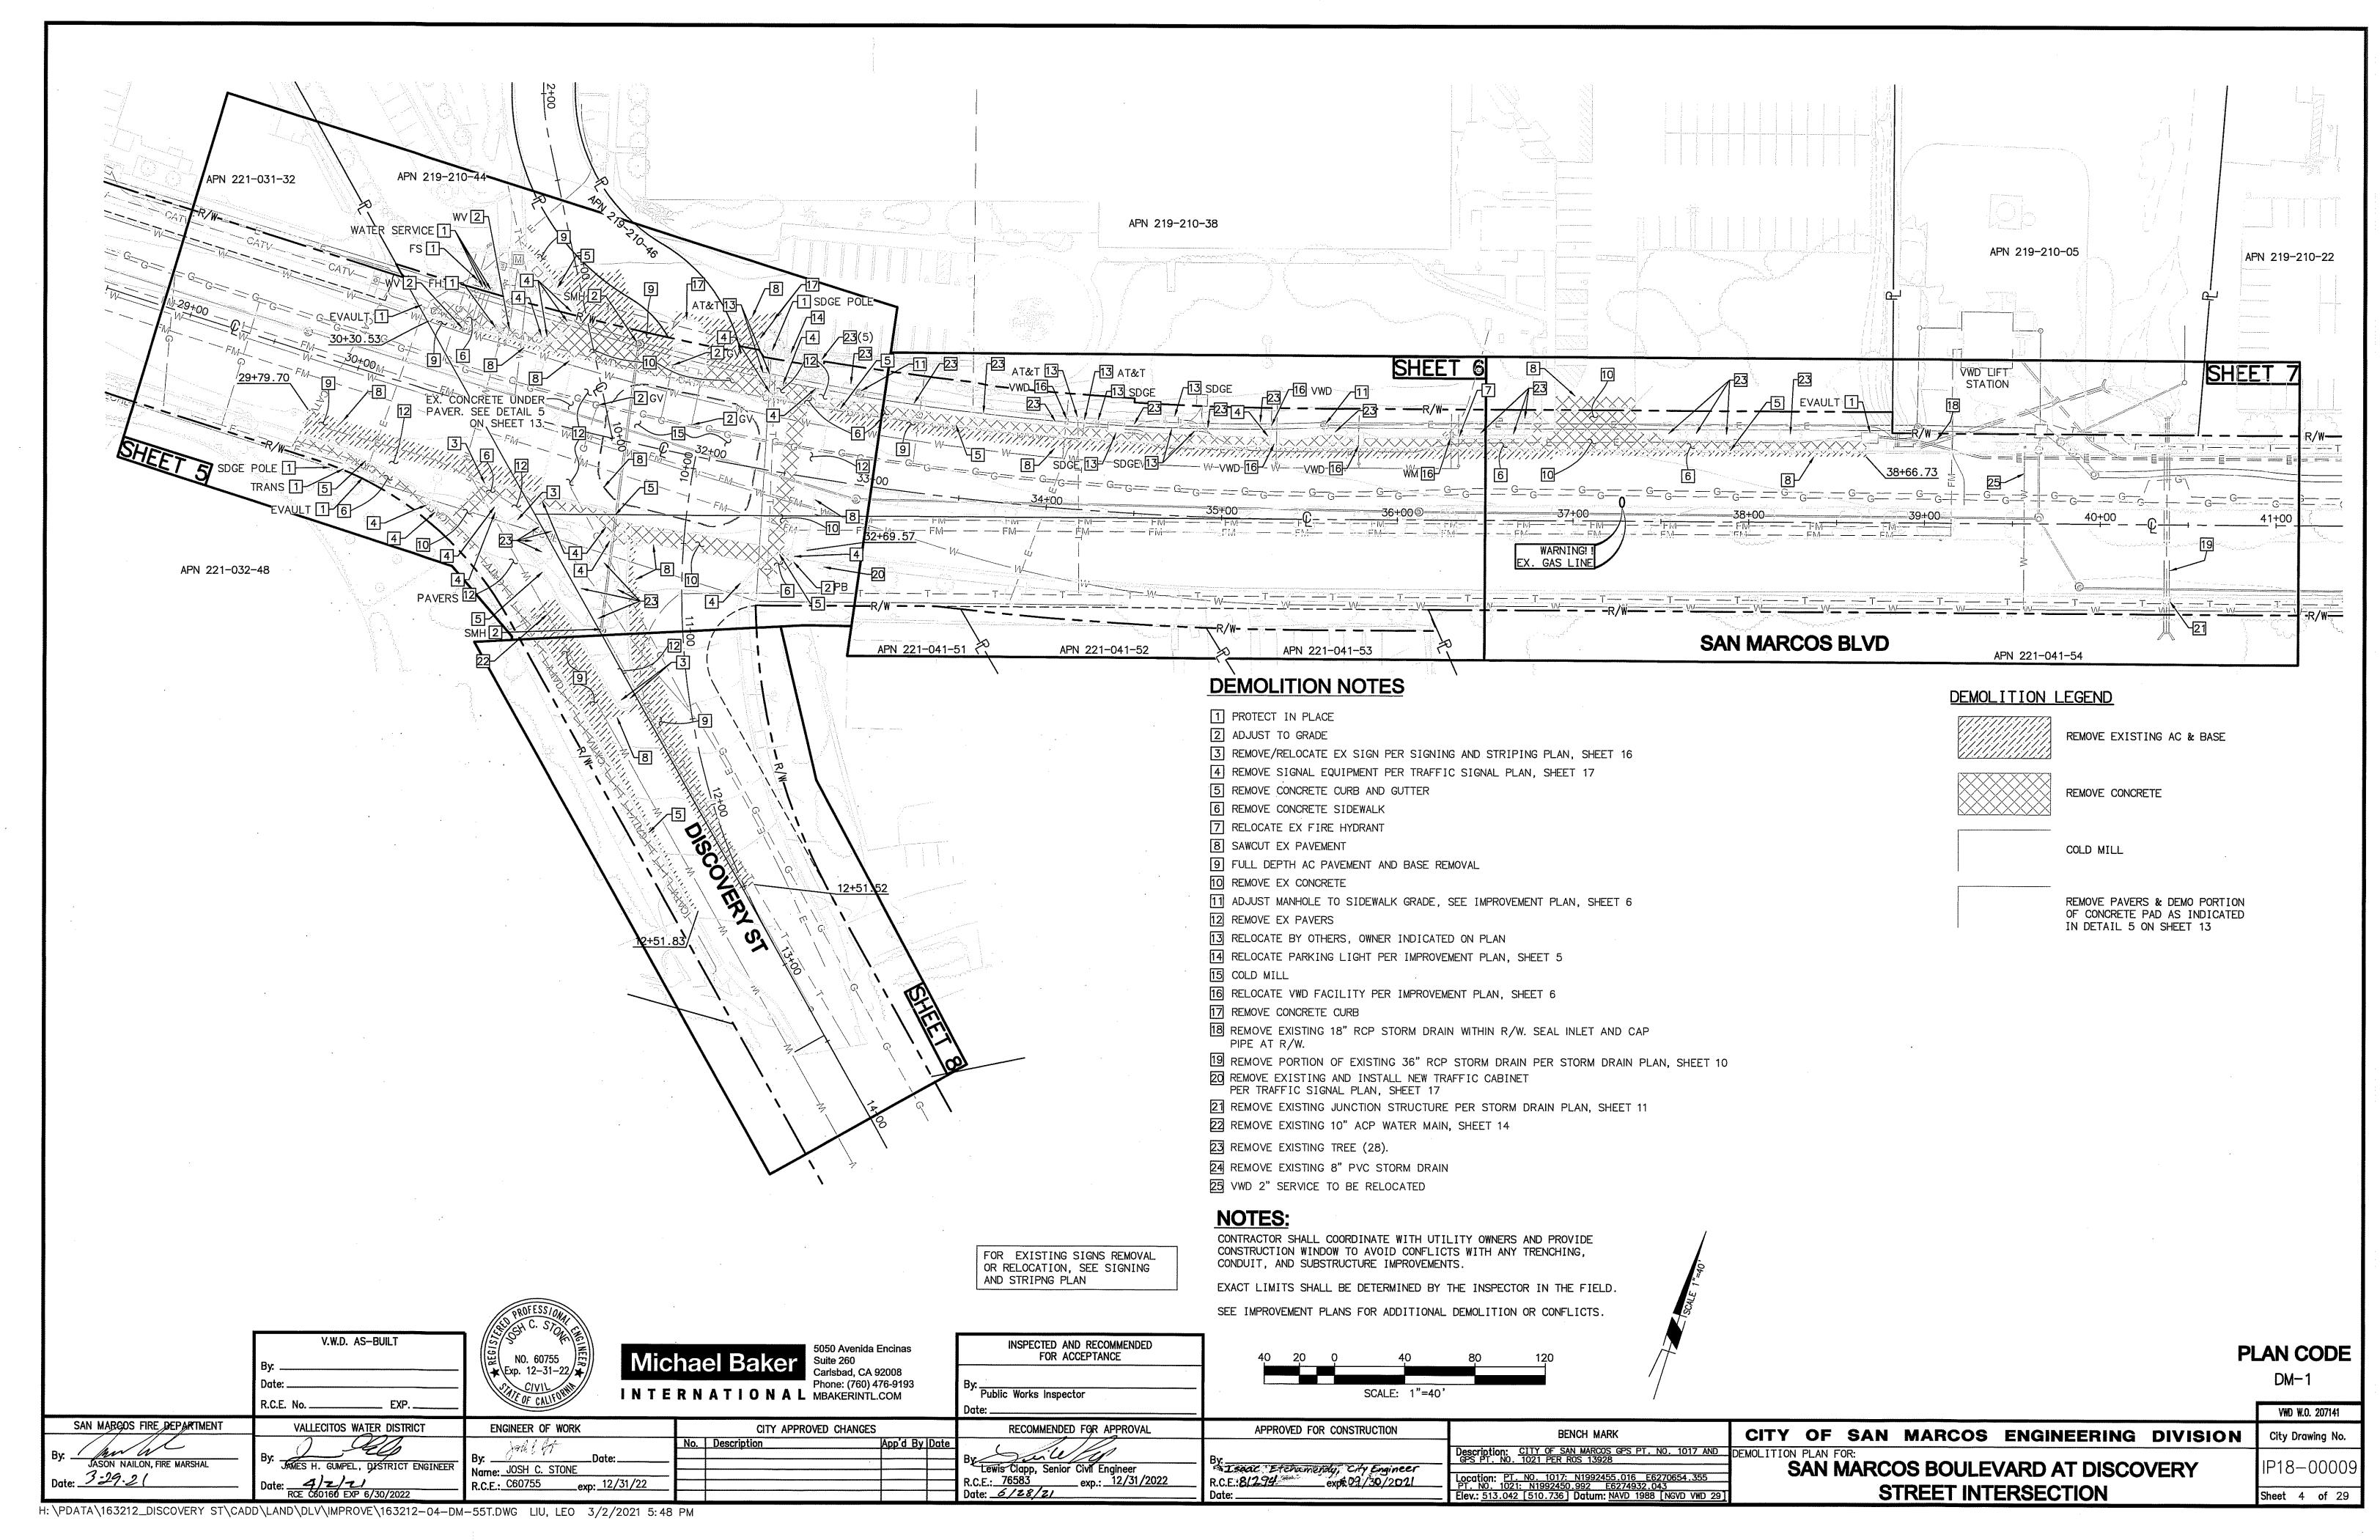


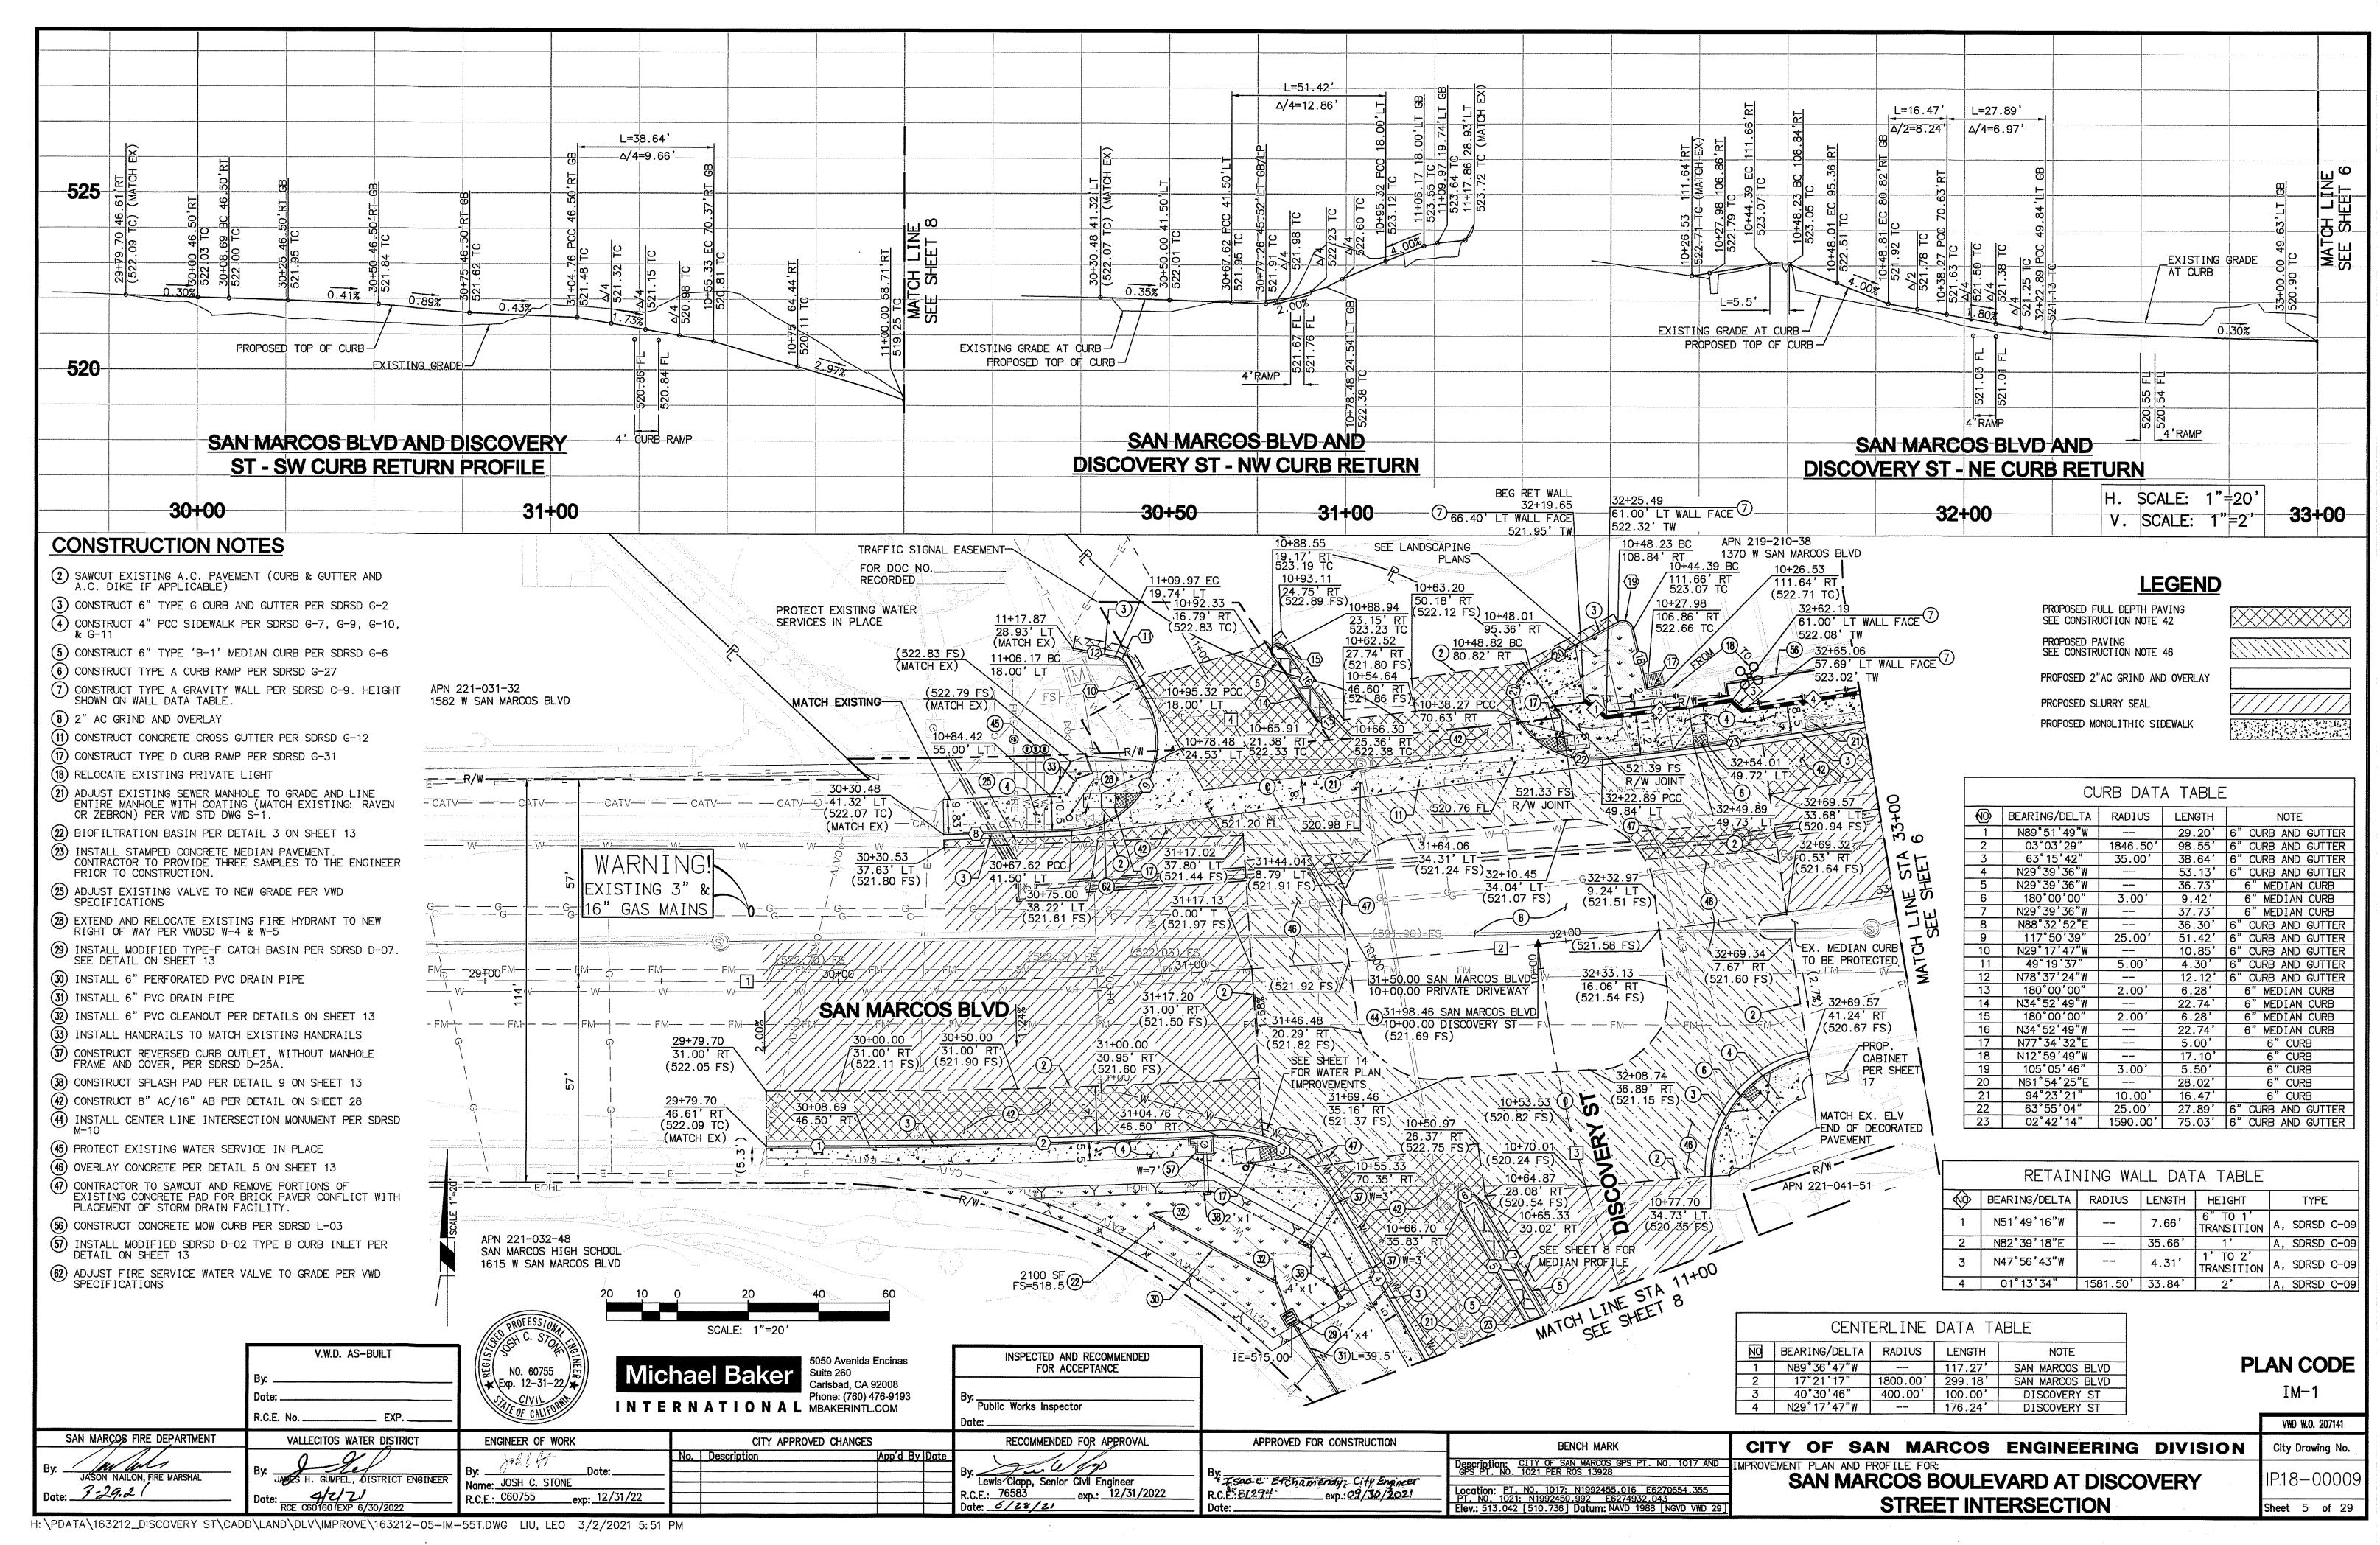


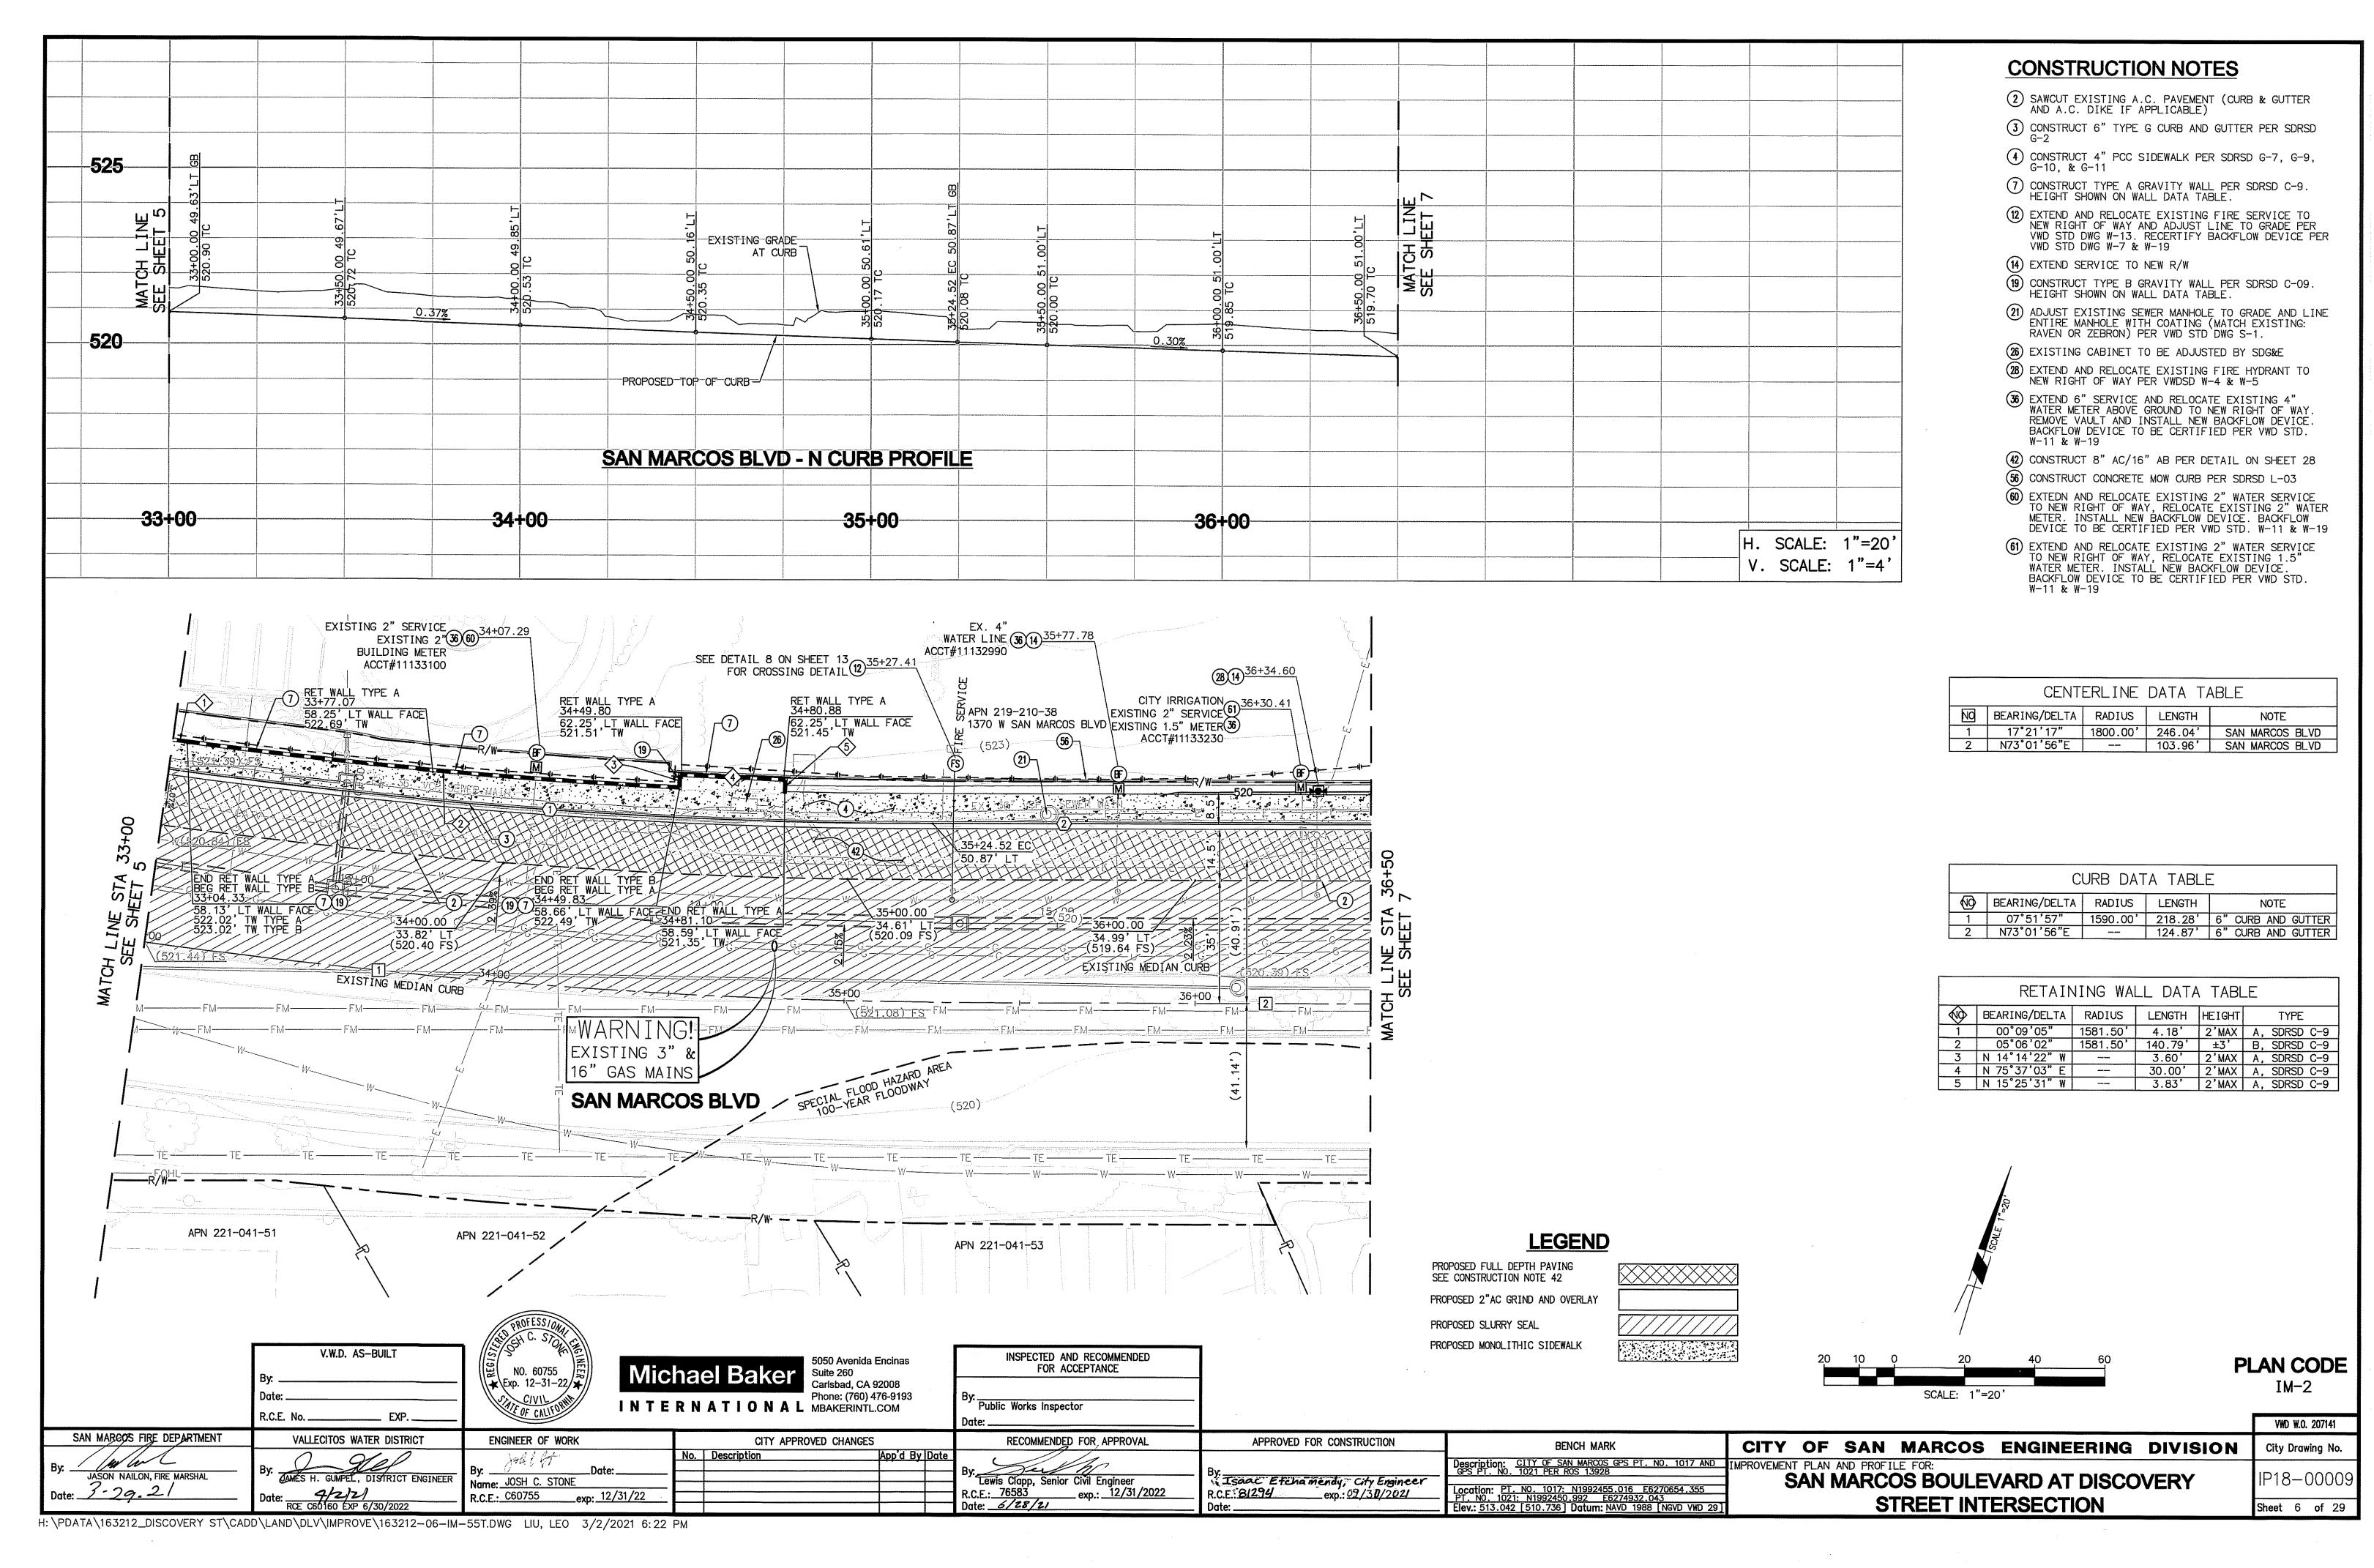



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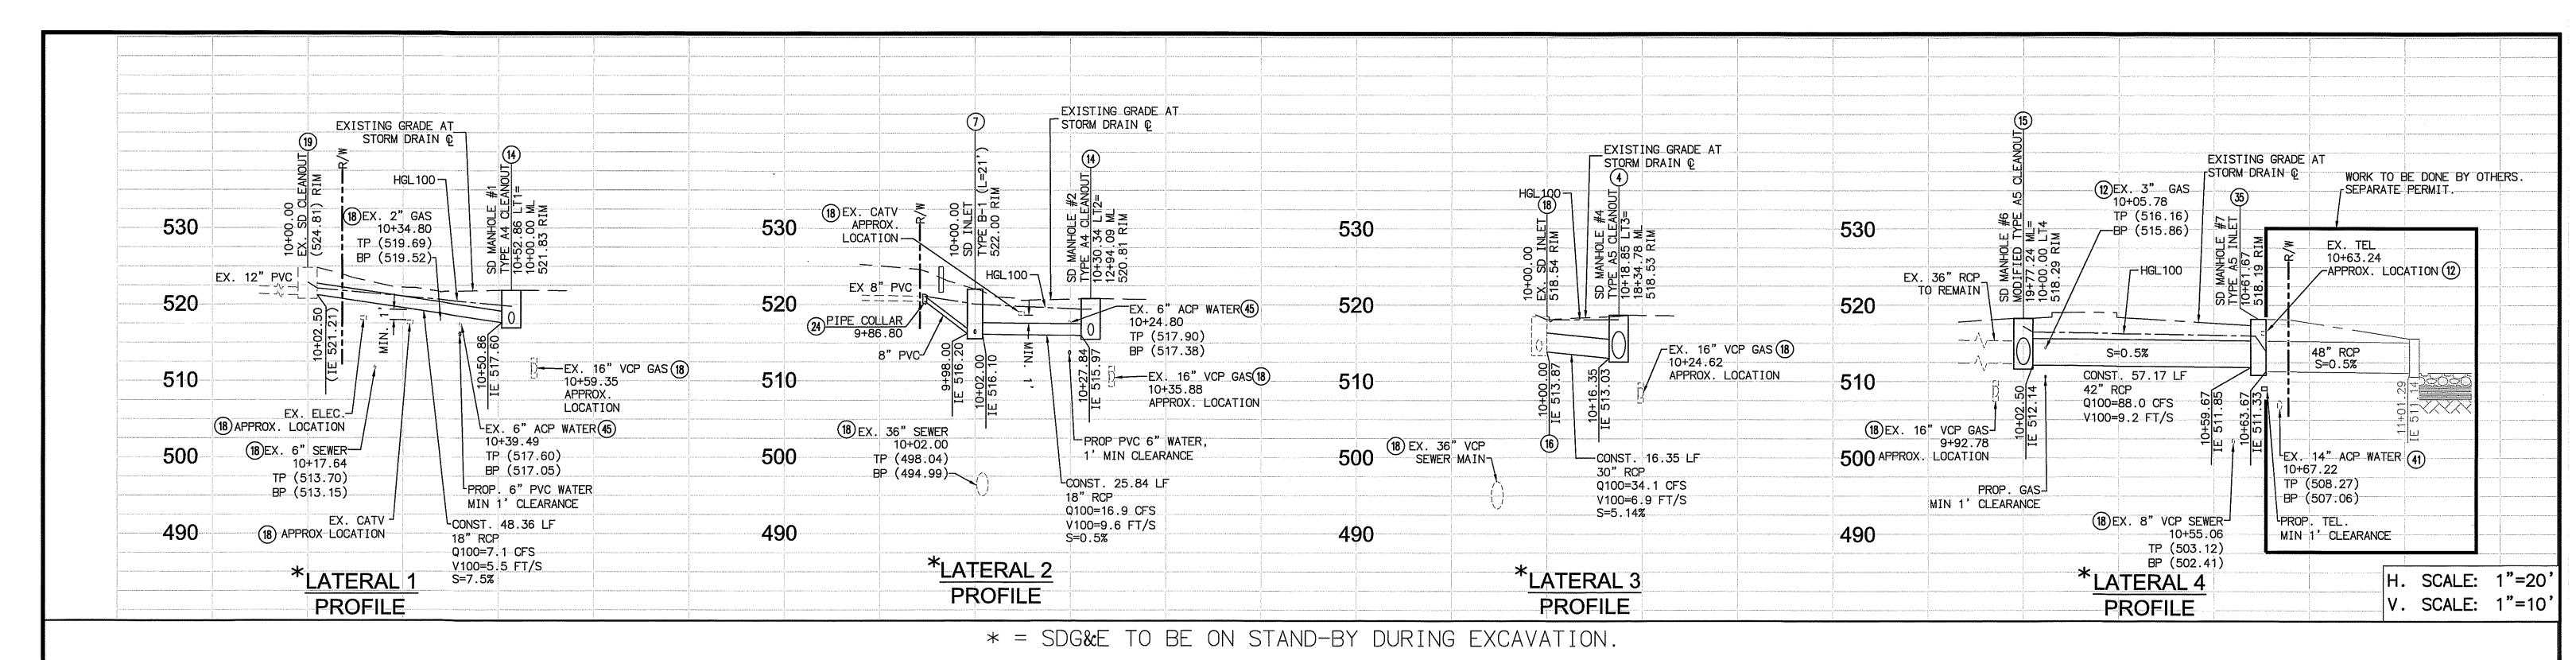





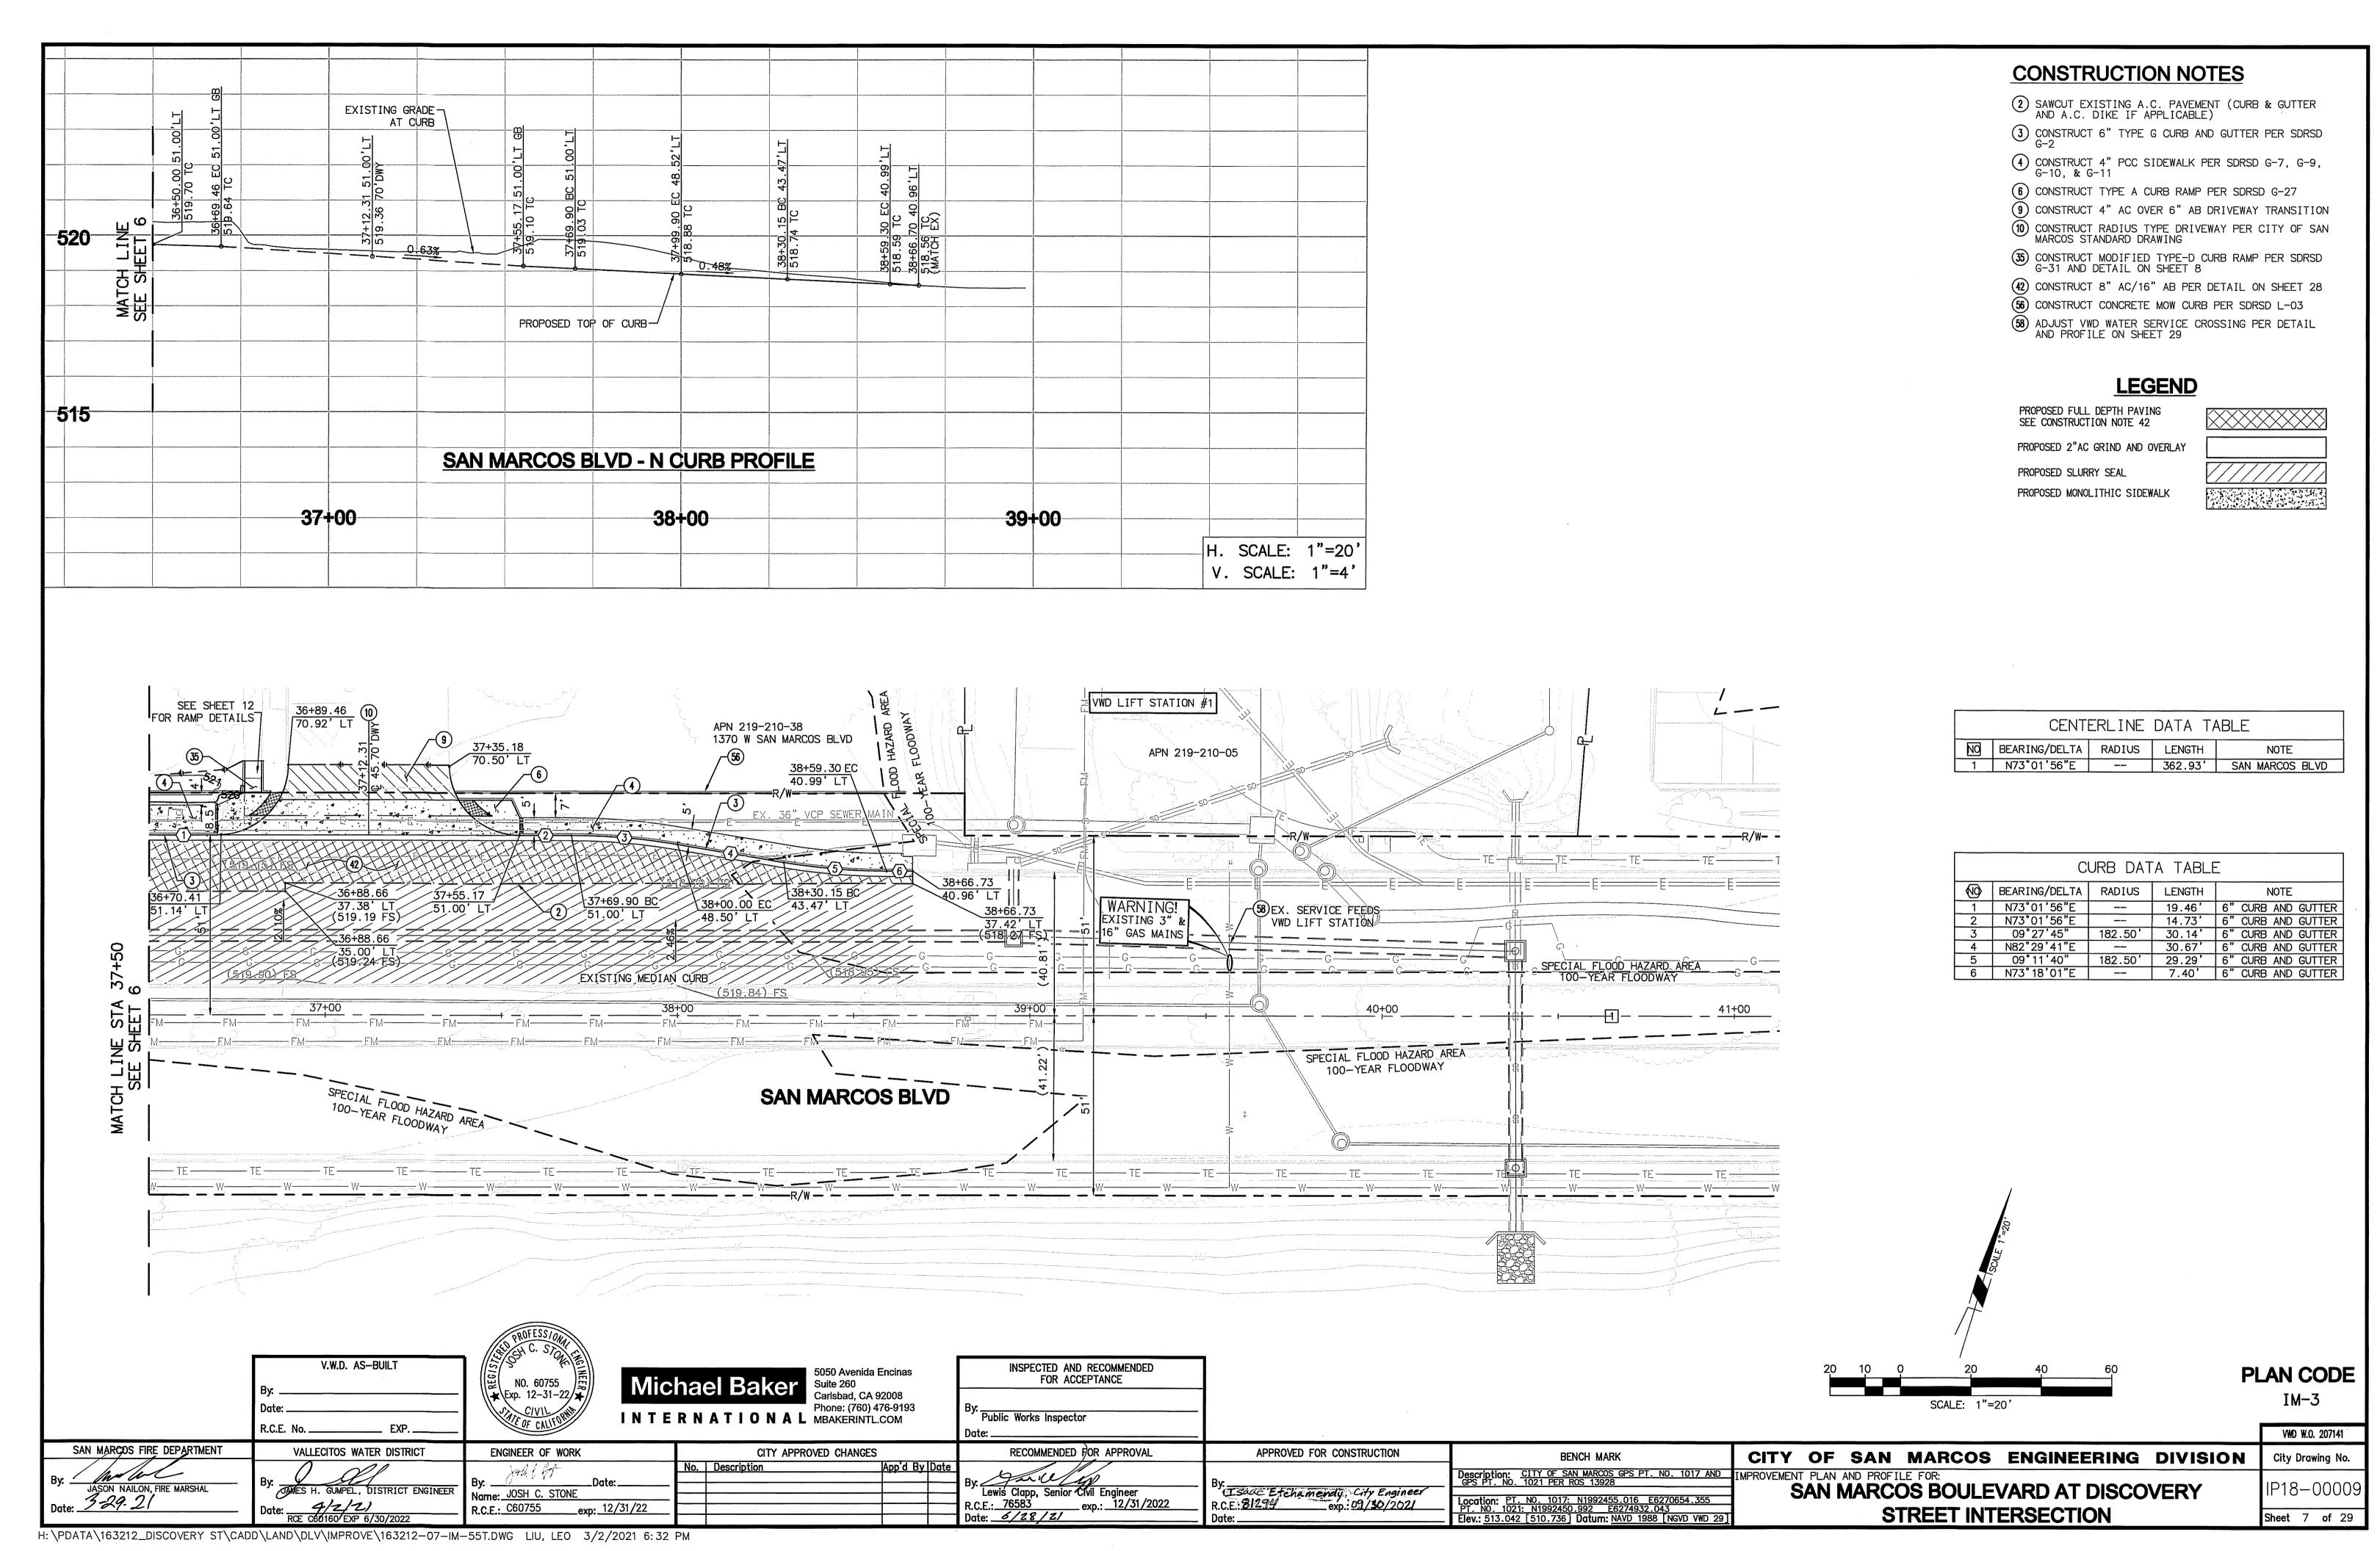


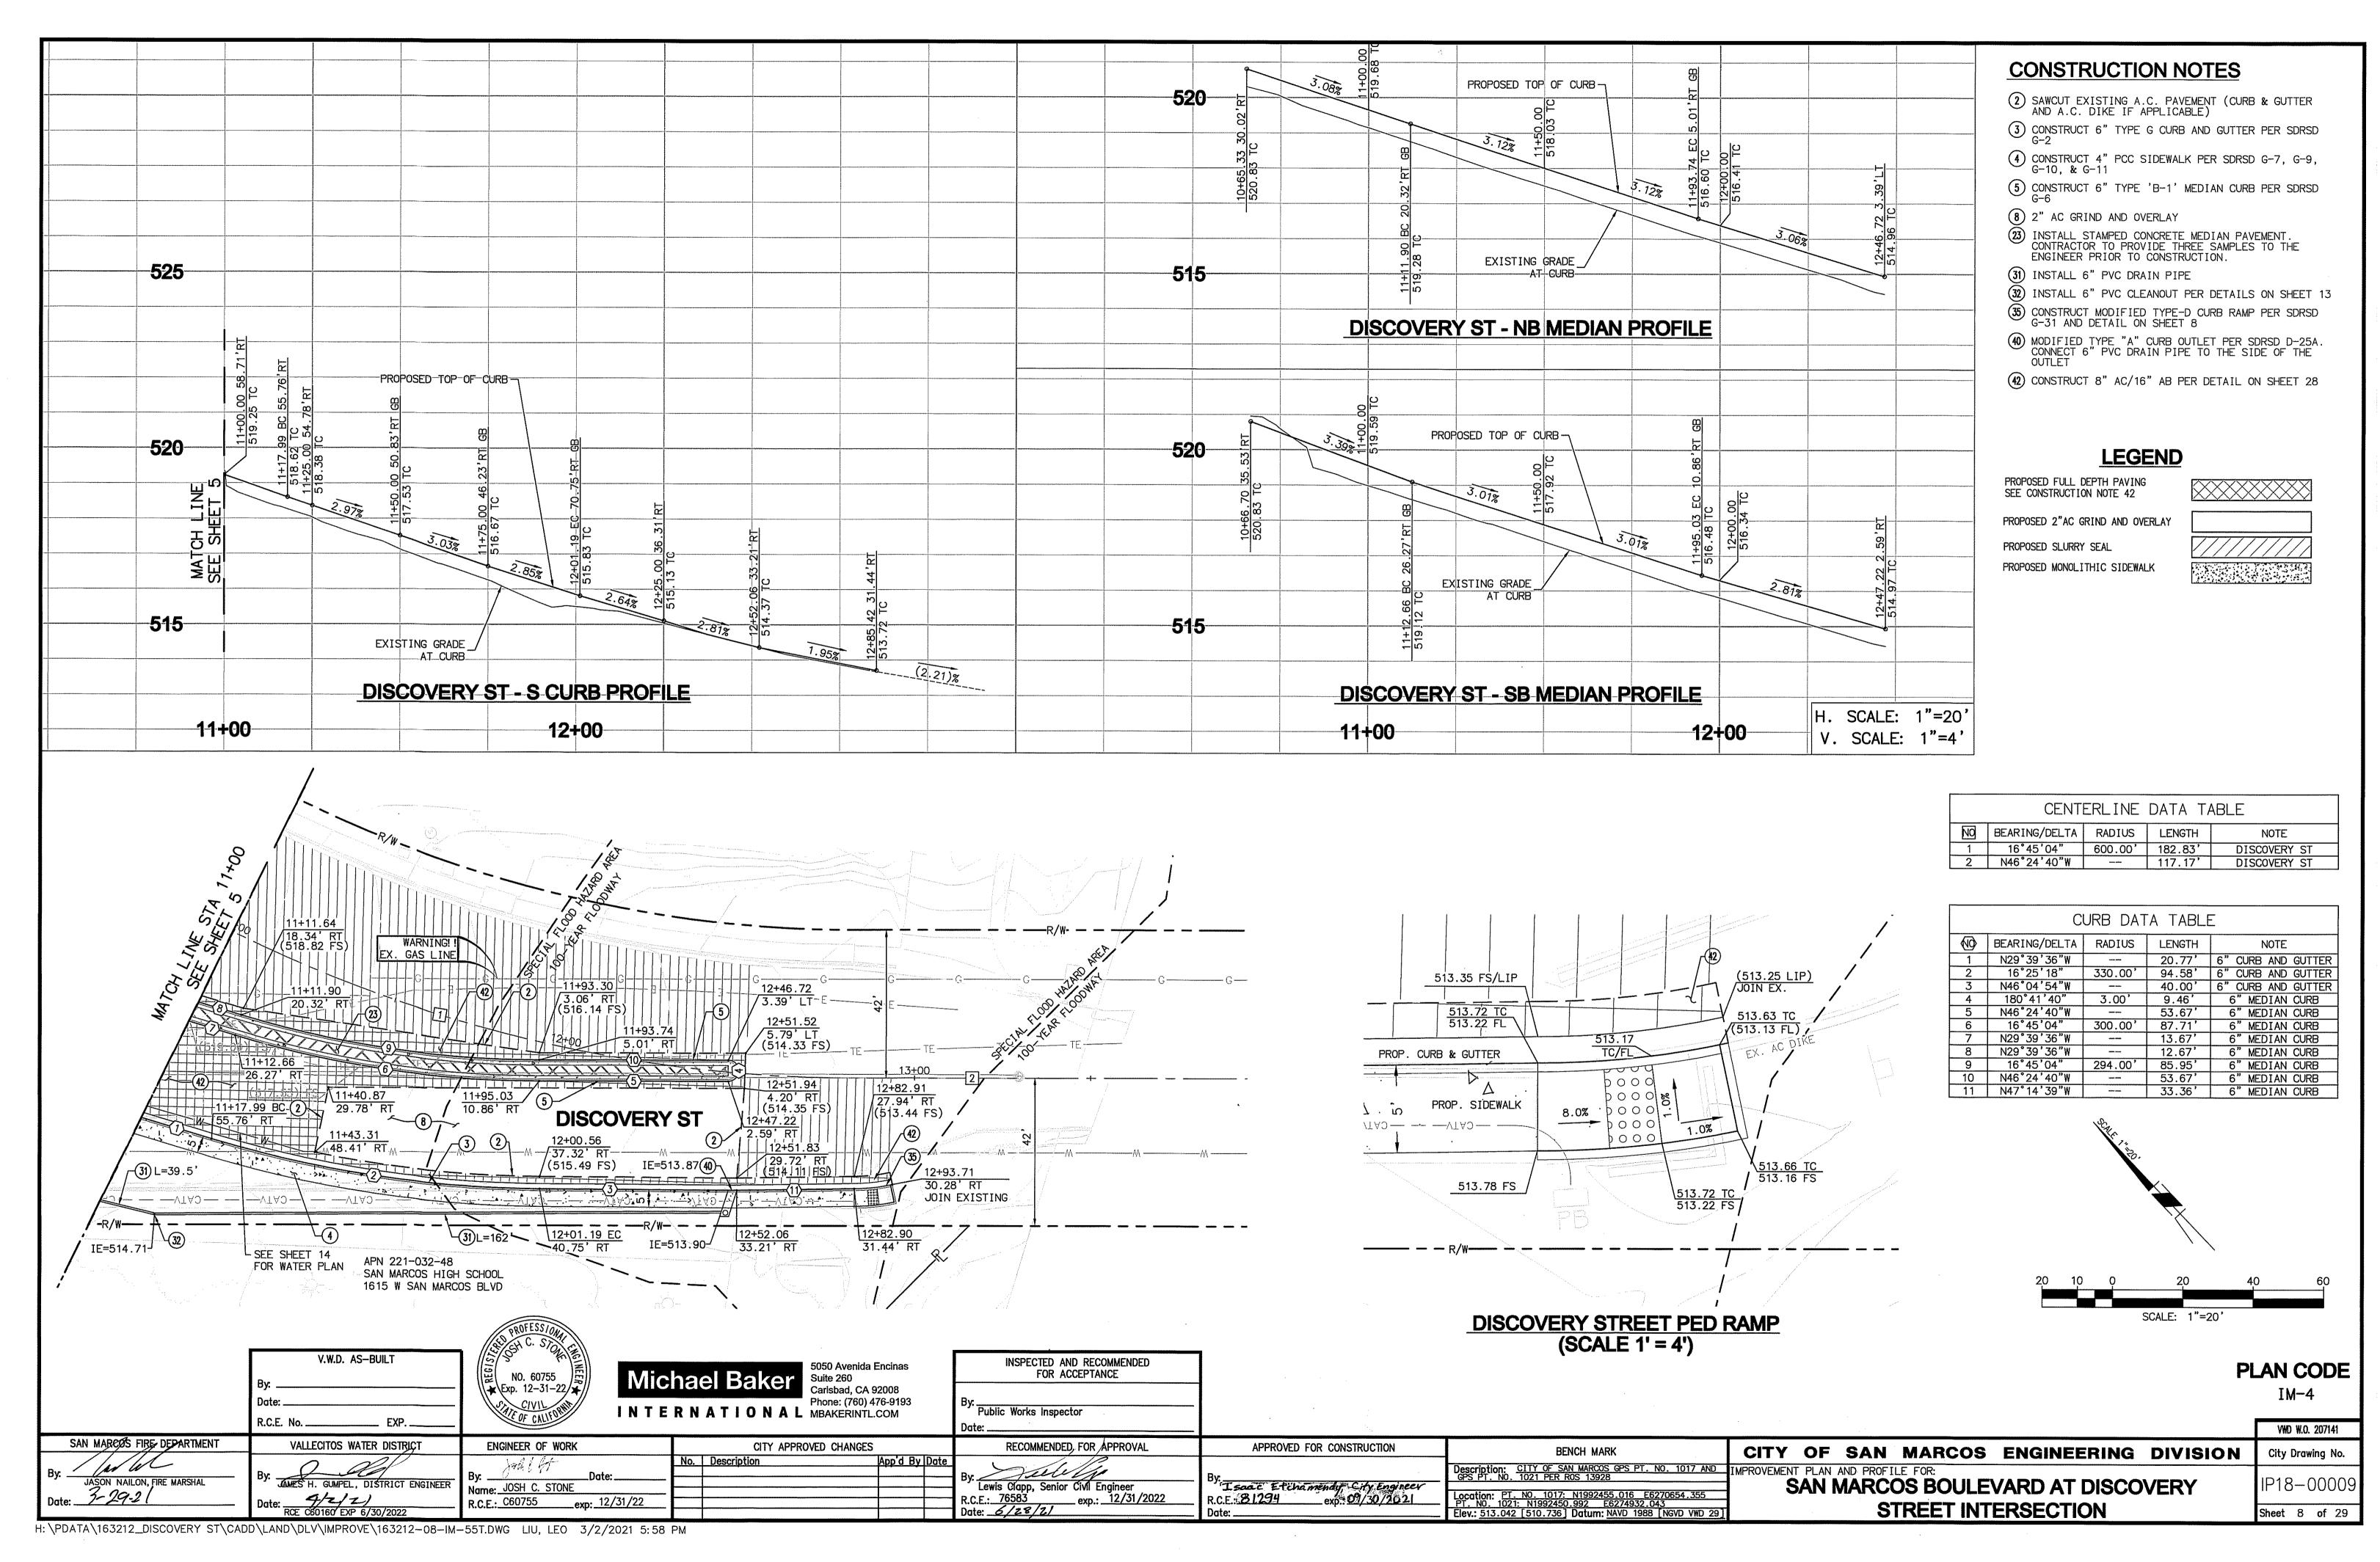


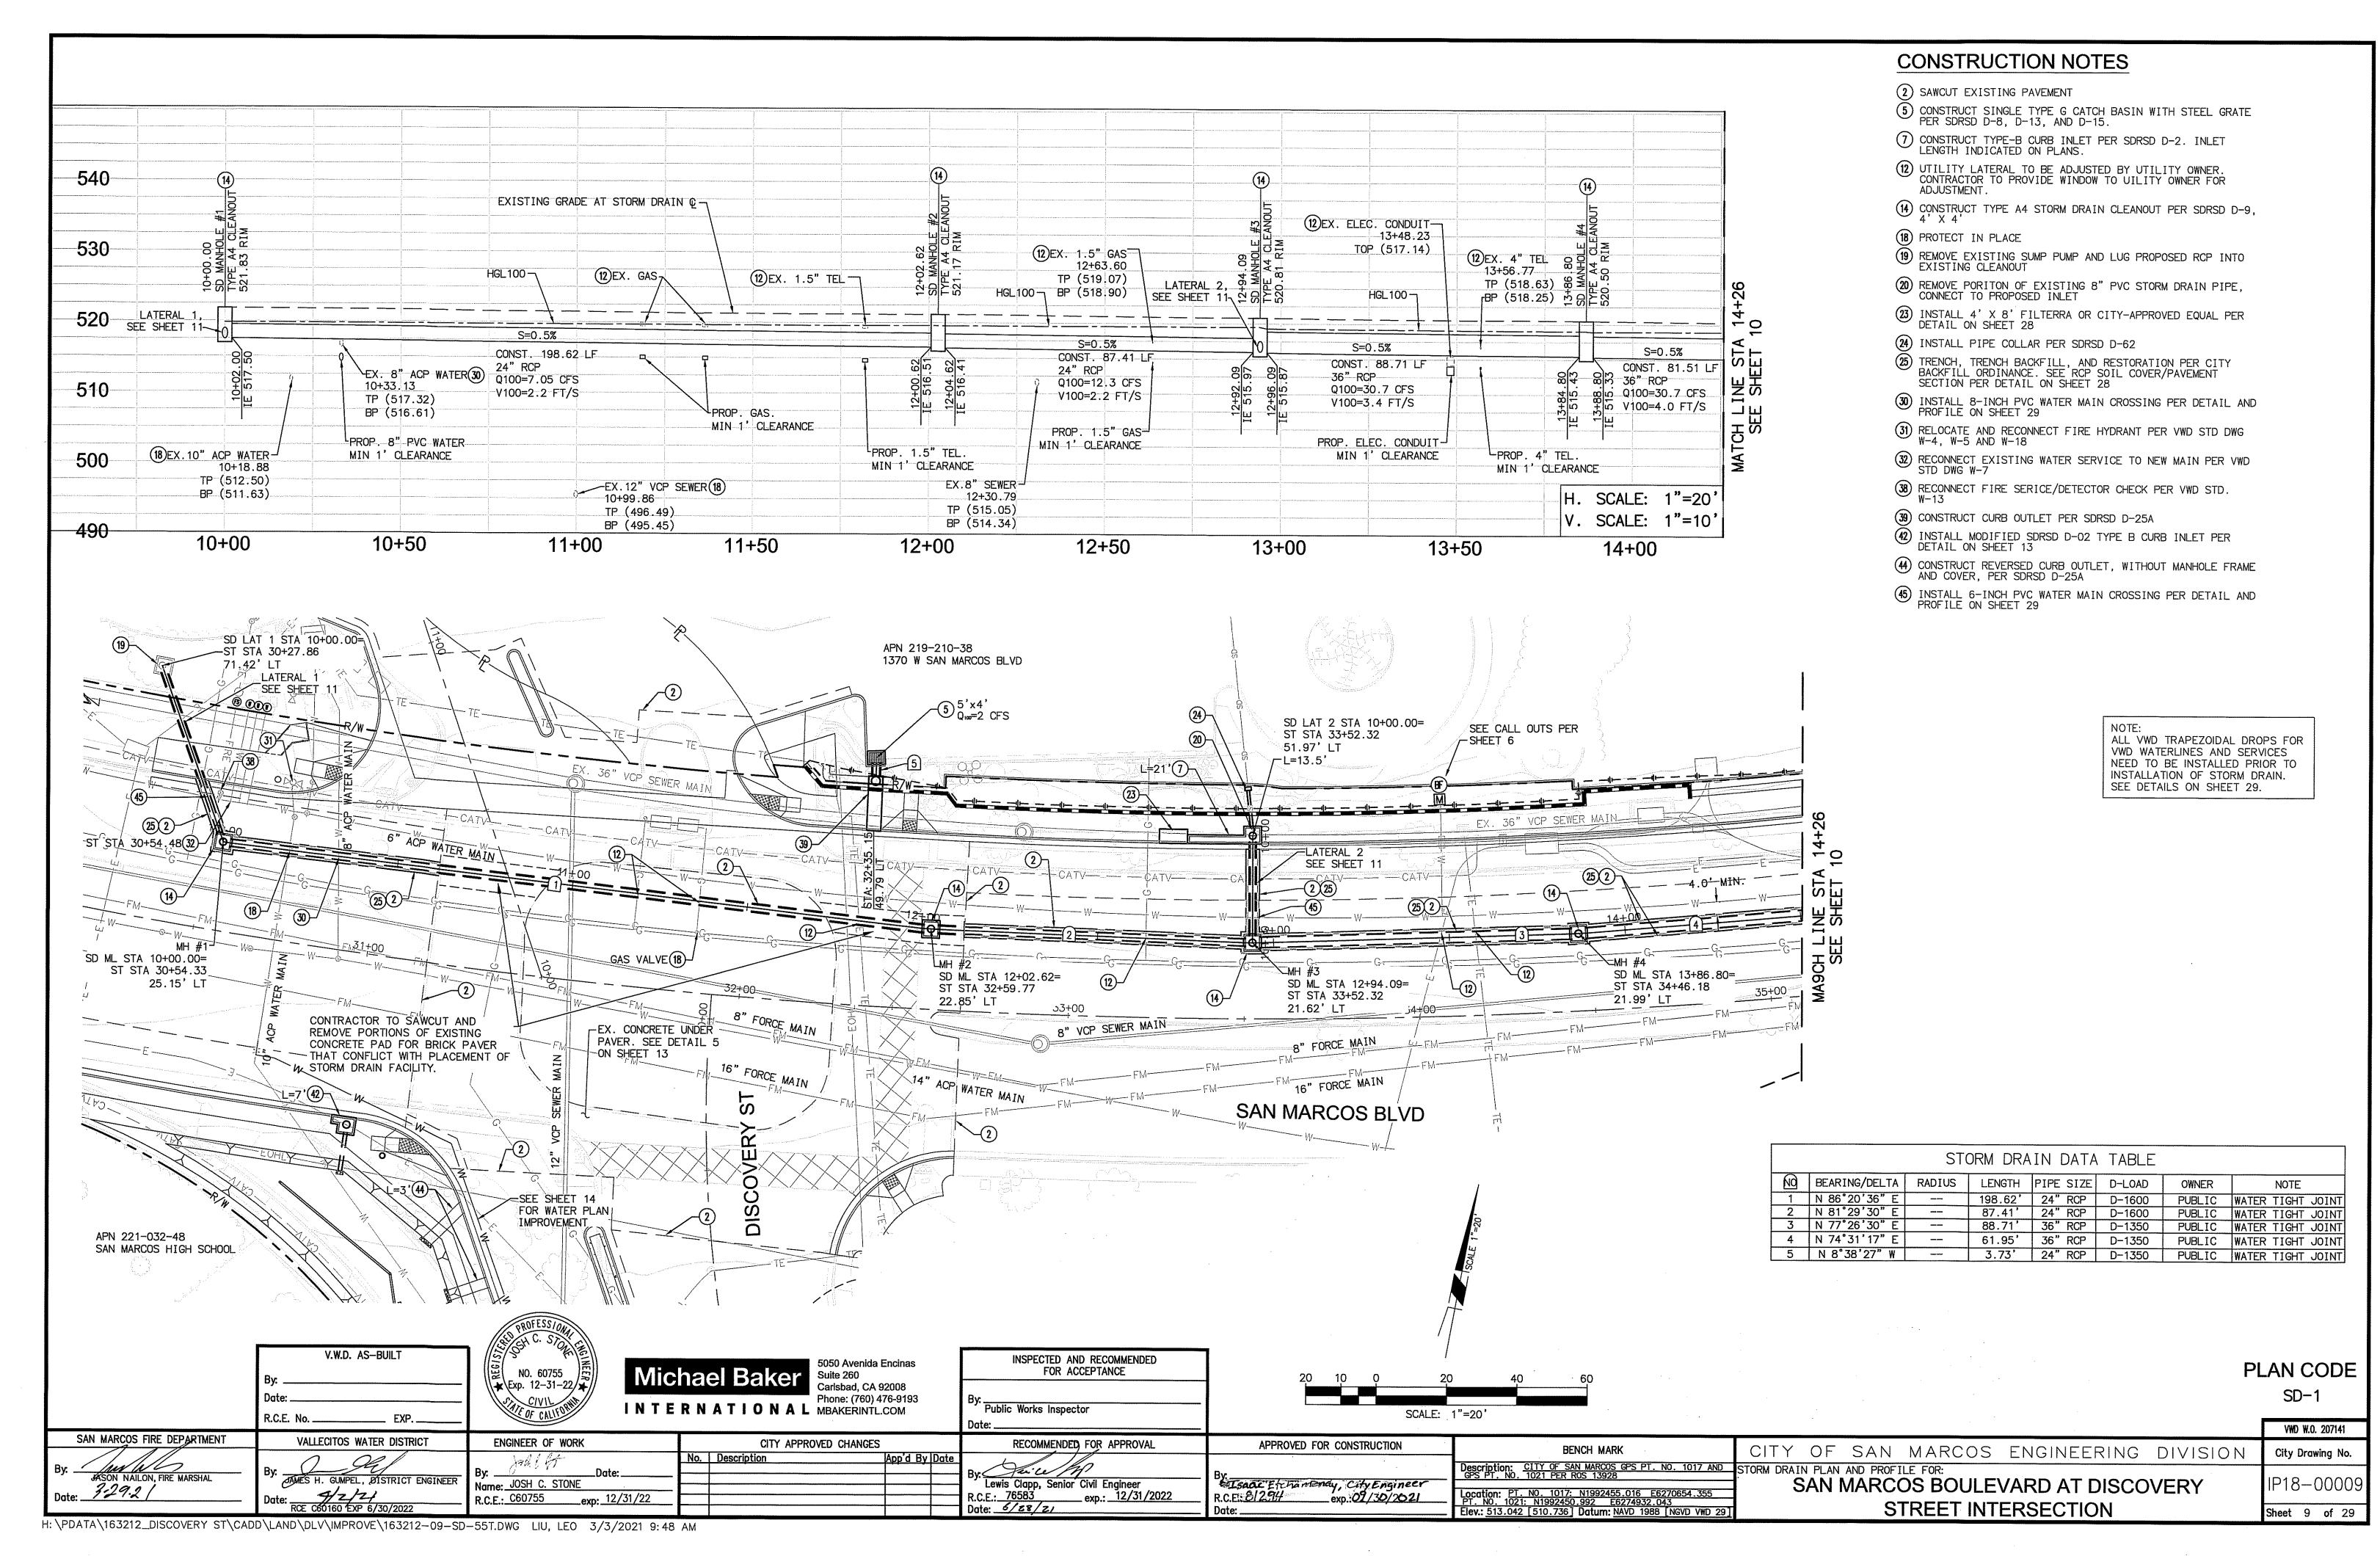-WORK TO BE DONE BY OTHERS. SEPARATE PERMIT.

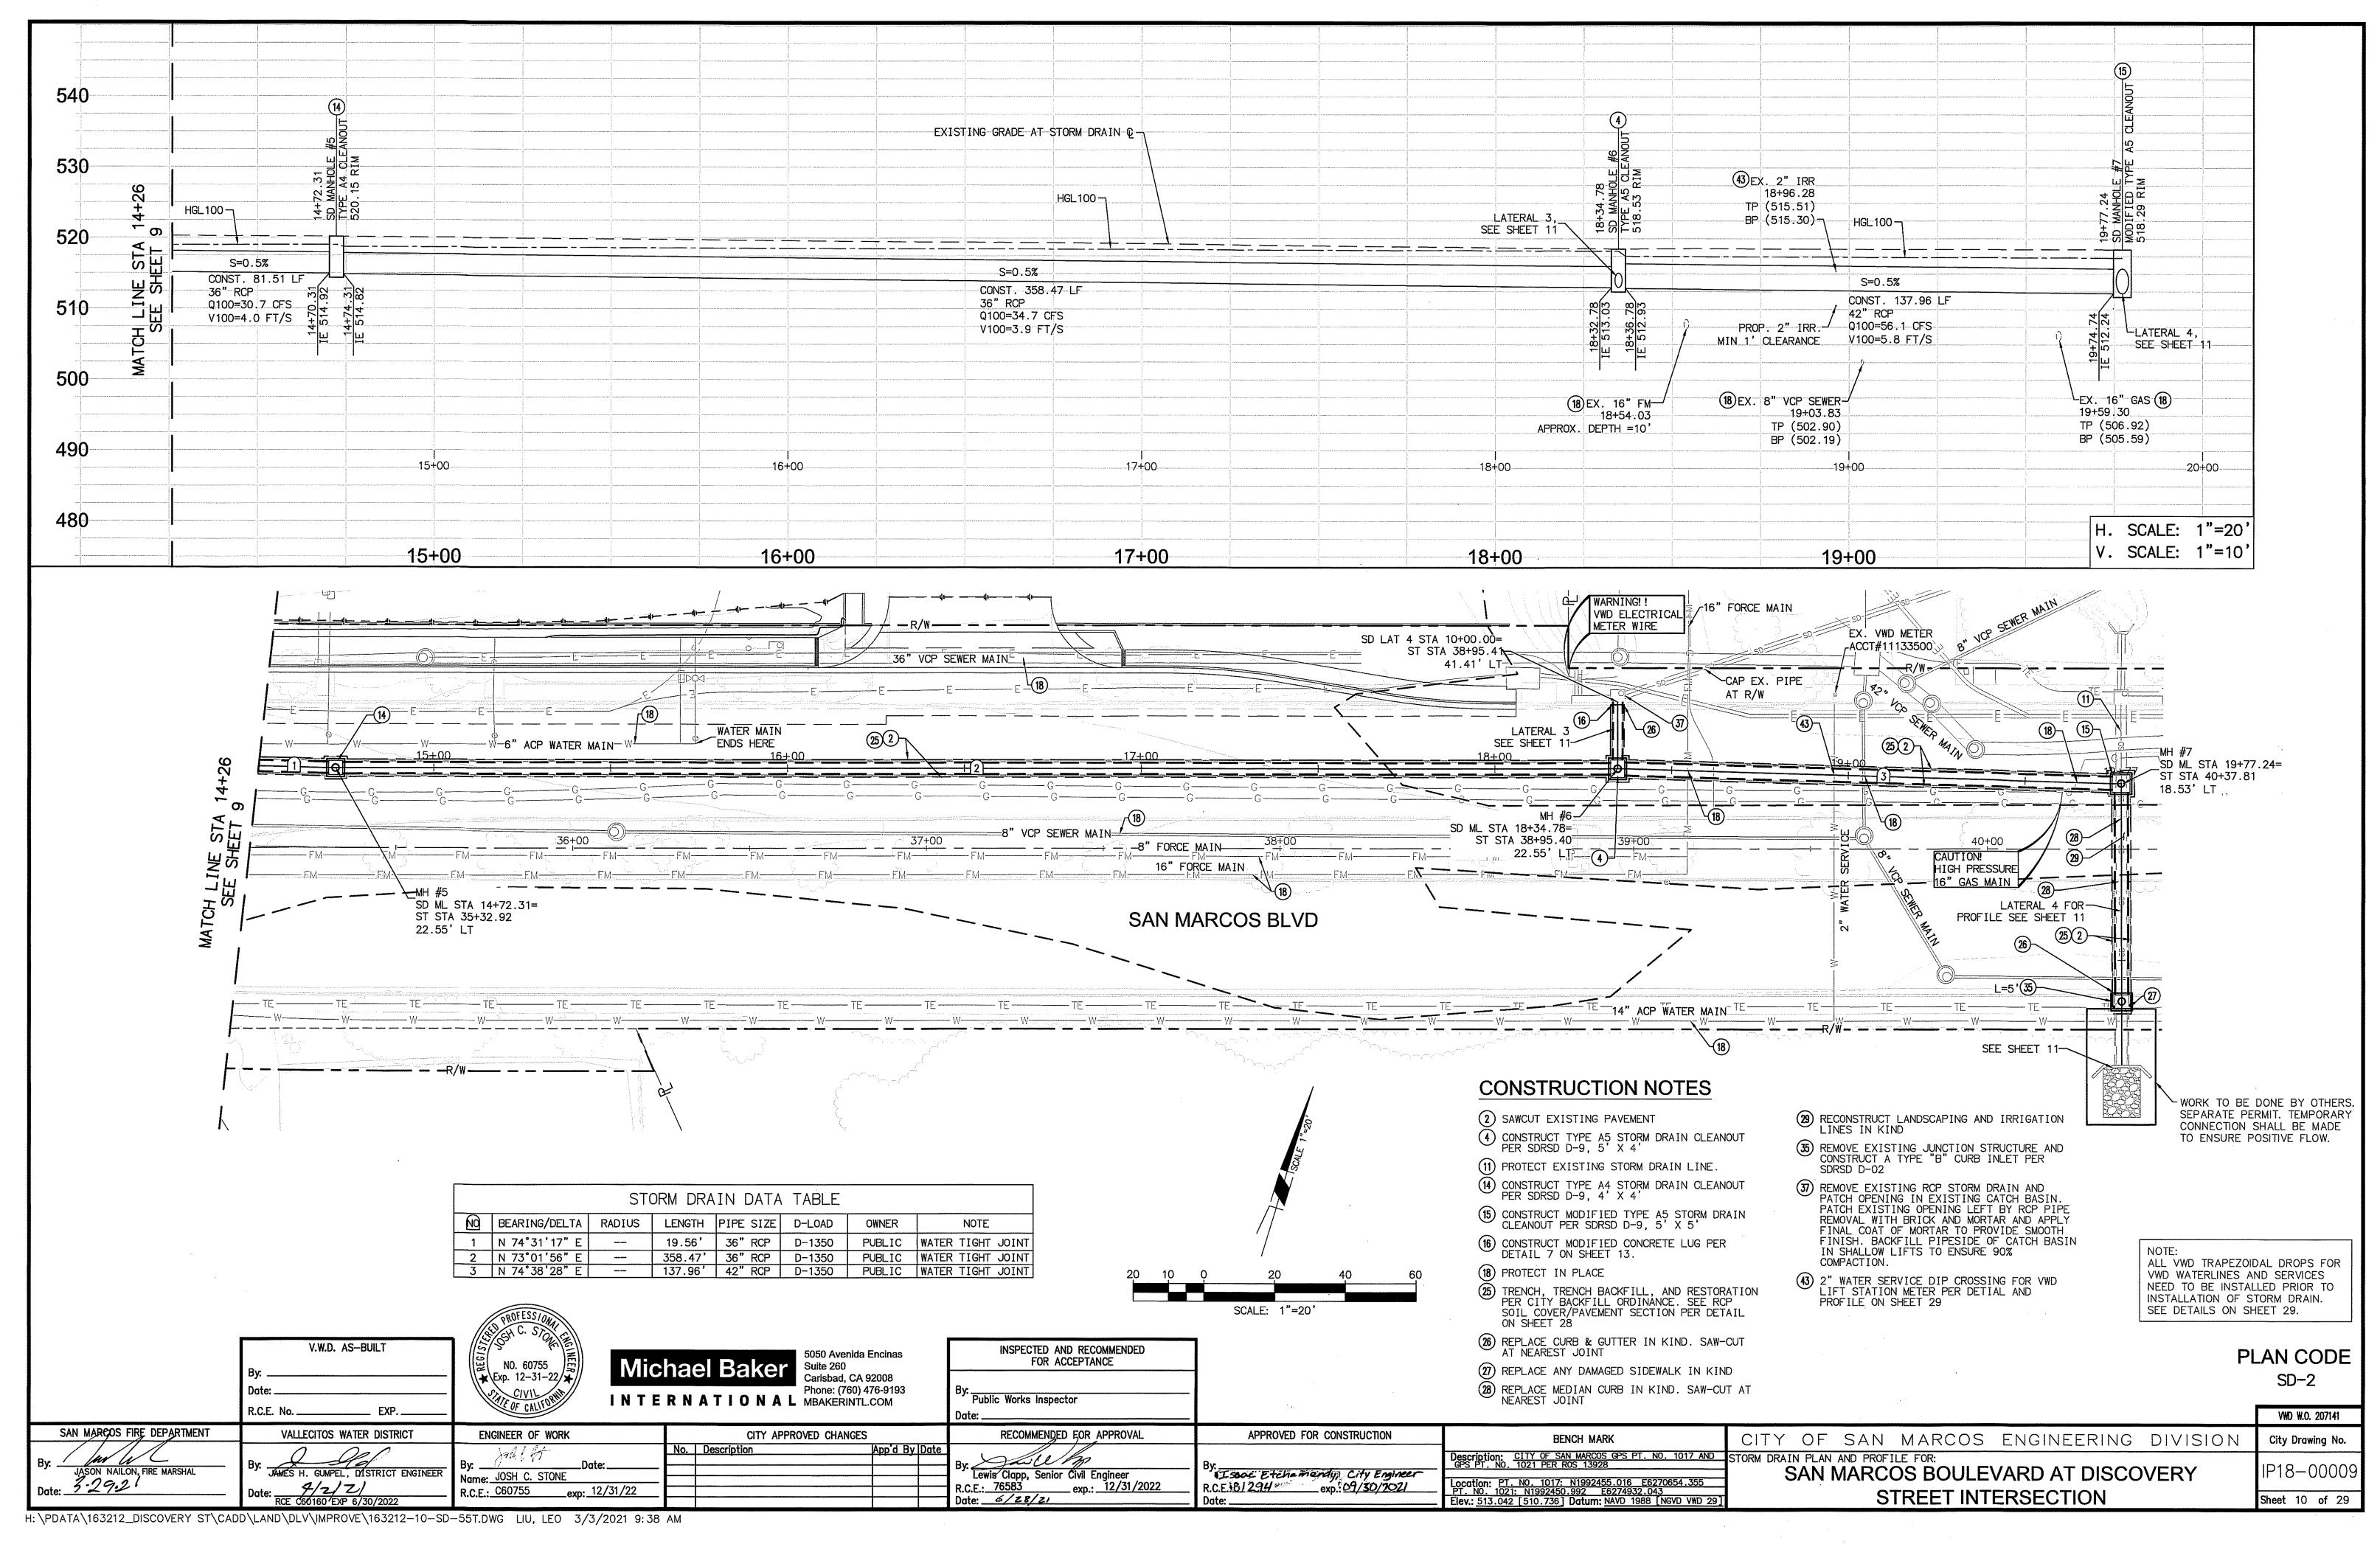

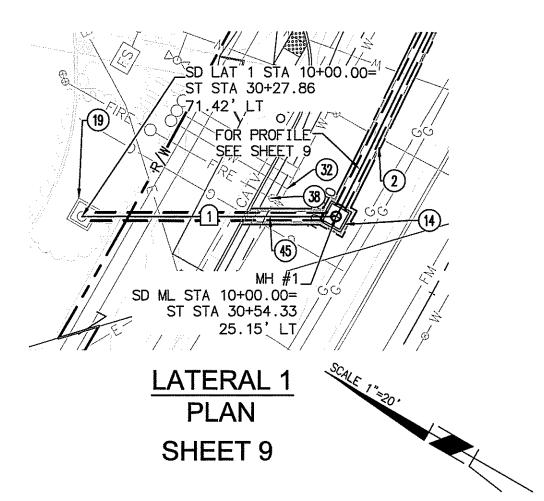

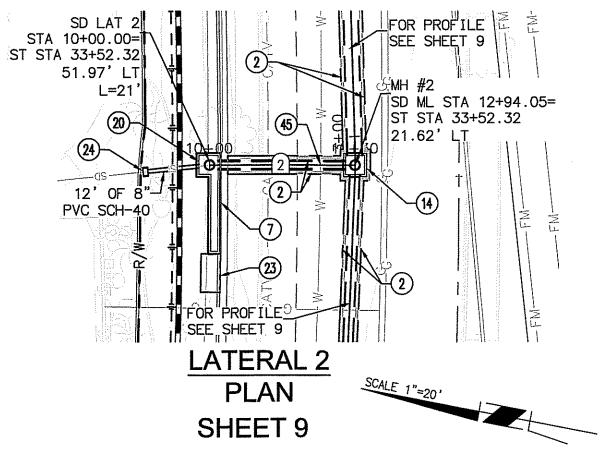

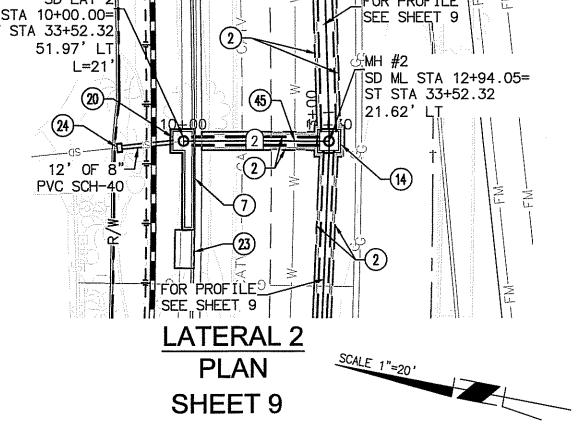

REMOVE EXISTING JUNCTION STRUCTURE AND CONSTRUCT A TYPE "B" CURB INLET PER SDRSD D-02

- 20 REMOVE PORITON OF EXISTING 8" PVC STORM DRAIN PIPE, CONNECT TO PROPOSED INLET 37) REMOVE EXISTING RCP STORM DRAIN AND PATCH OPENING IN EXISTING CATCH BASIN. PATCH EXISTING OPENING LEFT BY RCP PIPE REMOVAL WITH 23) INSTALL 4' X 8' FILTERRA OR CITY-APPROVED EQUAL PER DETAIL ON SHEET 28 BRICK AND MORTAR AND APPLY FINAL COAT OF MORTAR TO PROVIDE SMOOTH FINISH. BACKFILL PIPESIDE OF CATCH BASIN IN SHALLOW LIFTS TO
- (24) INSTALL PIPE COLLAR PER SDRSD D-62 ENSURE 90% COMPACTION. (26) REPLACE CURB & GUTTER IN KIND. SAW-CUT AT 38 RECONNECT FIRE SERICE/DETECTOR CHECK PER VWD NEAREST JOINT STD. W-13
- (27) REPLACE ANY DAMAGED SIDEWALK IN KIND (41) CONTRACTOR TO SUBMIT ON HOW TO PROTECT 14" ACP WATER WHILE DIGGING STORM DRAIN STRUCTURE (28) REPLACE MEDIAN CURB IN KIND. SAW-CUT AT NEAREST JOINT
- 45) INSTALL 6-INCH PVC WATER MAIN CROSSING PER DETAIL AND PROFILE ON SHEET 29 29 RECONSTRUCT LANDSCAPING AND IRRIGATION LINES

App'd By Date

NOTE: ALL VWD TRAPEZOIDAL DROPS FOR VWD WATERLINES AND SERVICES NEED TO BE INSTALLED PRIOR TO INSTALLATION OF STORM DRAIN. SEE DETAILS ON SHEET 29.

		STO	ORM DRA	IN DATA	TABLE		
NO	BEARING/DELTA	RADIUS	LENGTH	PIPE SIZE	D-LOAD	OWNER	NOTE
1	N30°00'00"W		48.36'	18" RCP	D-1600	PRIVATE	WATER TIGHT JOINT
2	N10°48'23"W		25.84	18" RCP	D-1600	PUBLIC	WATER TIGHT JOINT
3	N16°57'28"W		16.35'	30" RCP	D-1800	PUBLIC	WATER TIGHT JOINT
4	N17°07'40"W		57.17°	42" RCP	D-1350	PUBLIC	WATER TIGHT JOINT
5	N17°07'40"W		37.62'	48" RCP	D-2000	PUBLIC	WORK TO BE DONE BY OTHE SEPARATE PERMIT.

SD ML STA 19+76.97=

ST STA 40+37.81

FOR PROFILE SEE SHEET 9

LATERAL 4

PLAN

SHEET 10

18.53' LT.

CONSTRUCTION NOTES


(2) SAWCUT EXISTING PAVEMENT

SDRSD D-9, 5' X 4'

- 4 CONSTRUCT TYPE A5 STORM DRAIN CLEANOUT PER
- 7 CONSTRUCT TYPE-B CURB INLET PER SDRSD D-2. INLET LENGTH INDICATED ON PLANS.
- UTILITY LATERAL TO BE ADJUSTED BY UTILITY OWNER. CONTRACTOR TO PROVIDE WINDOW TO UILITY OWNER FOR ADJUSTMENT.
- (14) CONSTRUCT TYPE A4 STORM DRAIN CLEANOUT PER SDRSD D-9, 4' X 4'
- (15) CONSTRUCT MODIFIED TYPE A5 STORM DRAIN CLEANOUT PER SDRSD D-9, 5' X 5'
- (16) CONSTRUCT MODIFIED CONCRETE LUG PER DETAIL 7 ON SHEET 13.
- (18) PROTECT IN PLACE

SAN MARCOS FIRE DEPARTMENT

JASON NAILON, FIRE MARSHAL

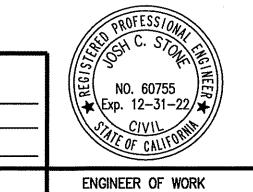

IN KIND

19) REMOVE EXISTING SUMP PUMP AND LUG PROPOSED RCP INTO EXISTING CLEANOUT

32) RECONNECT EXISTING WATER SERVICE TO NEW MAIN PER VWD STD DWG W-7

Michael Baker INTERNATIONAL MBAKERINTL.COM

No. Description

5050 Avenida Encinas Carlsbad, CA 92008 Phone: (760) 476-9193 CITY APPROVED CHANGES

Public Works Inspector RECOMMENDED FOR APPROVAL y: Lewis Clapp, Senior Civil Engineer R.C.E. 81294 exp.: 69/30/2021 _exp.: 12/31/2022 Date: 6/28/2/

INSPECTED AND RECOMMENDED

FOR ACCEPTANCE

SCALE: 1"=20' APPROVED FOR CONSTRUCTION

22.55' LT

__FOR PROFILE

LATERAL 3

PLAN

SHEET 10

SEE SHEET 10

BENCH MARK

Location: PT. NO. 1017: N1992455.016 E6270654.355 PT. NO. 1021: N1992450.992 E6274932.043 Elev.: 513.042 [510.736] Datum: NAVD 1988 [NGVD VWD 29

Description: CITY OF SAN MARCOS GPS PT. NO. 1017 AND GPS PT. NO. 1021 PER ROS 13928

PLAN CODE SD-3

Sheet 11 of 29

	JASON NAILON, FIRE MARSHAL Date: 29-21	Date: RCE C60160 EXP 6/30/2022	Name: <u>JOS</u> R.C.E.: <u>C6</u>		exp: 12/31/22	2	
1	H:\PDATA\163212_DISCOVERY ST\CAD	D\LAND\DLV\IMPROVE\163212-11-SD-	-55T.DWG	LIU, LEO	3/3/2021	9:25 A	M


V.W.D. AS-BUILT


VALLECITOS WATER DISTRICT


JAMES H. GUMPEL, DISTRICT ENGINEER

VWD W.O. 207141 CITY OF SAN MARCOS ENGINEERING DIVISION City Drawing No. STORM DRAIN PLAN AND PROFILE FOR: SAN MARCOS BOULEVARD AT DISCOVERY IP18-00009

STREET INTERSECTION

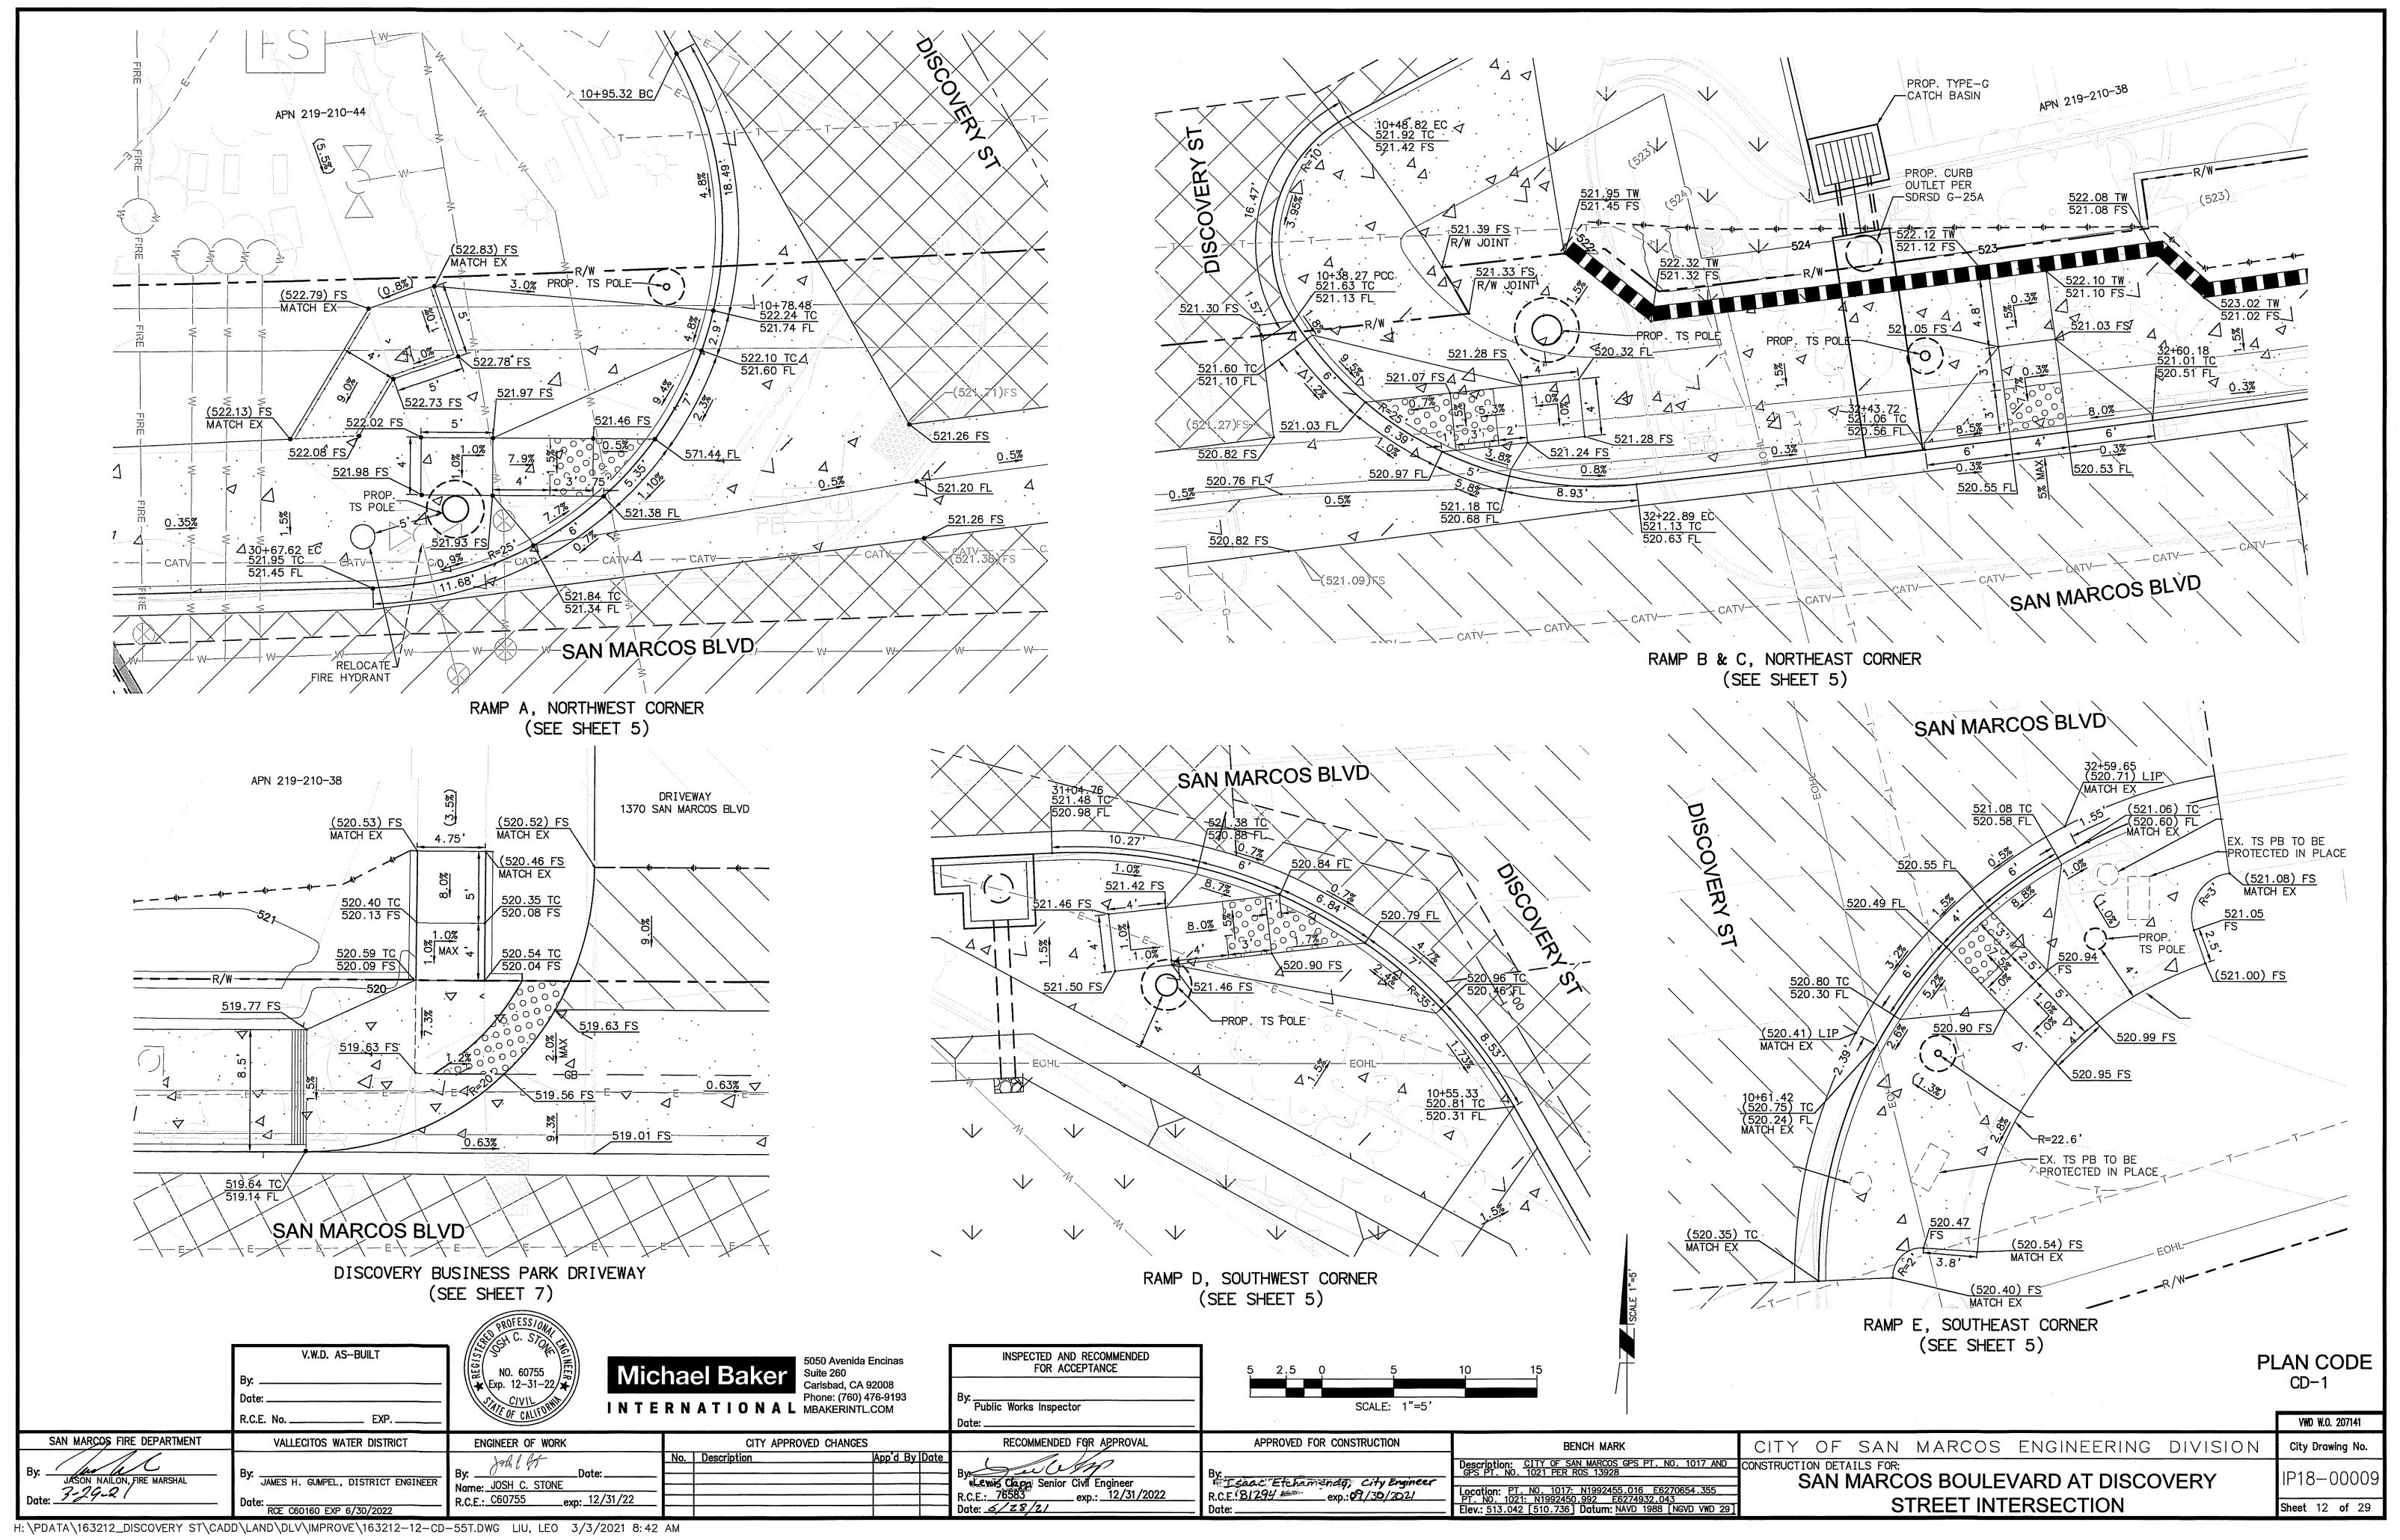

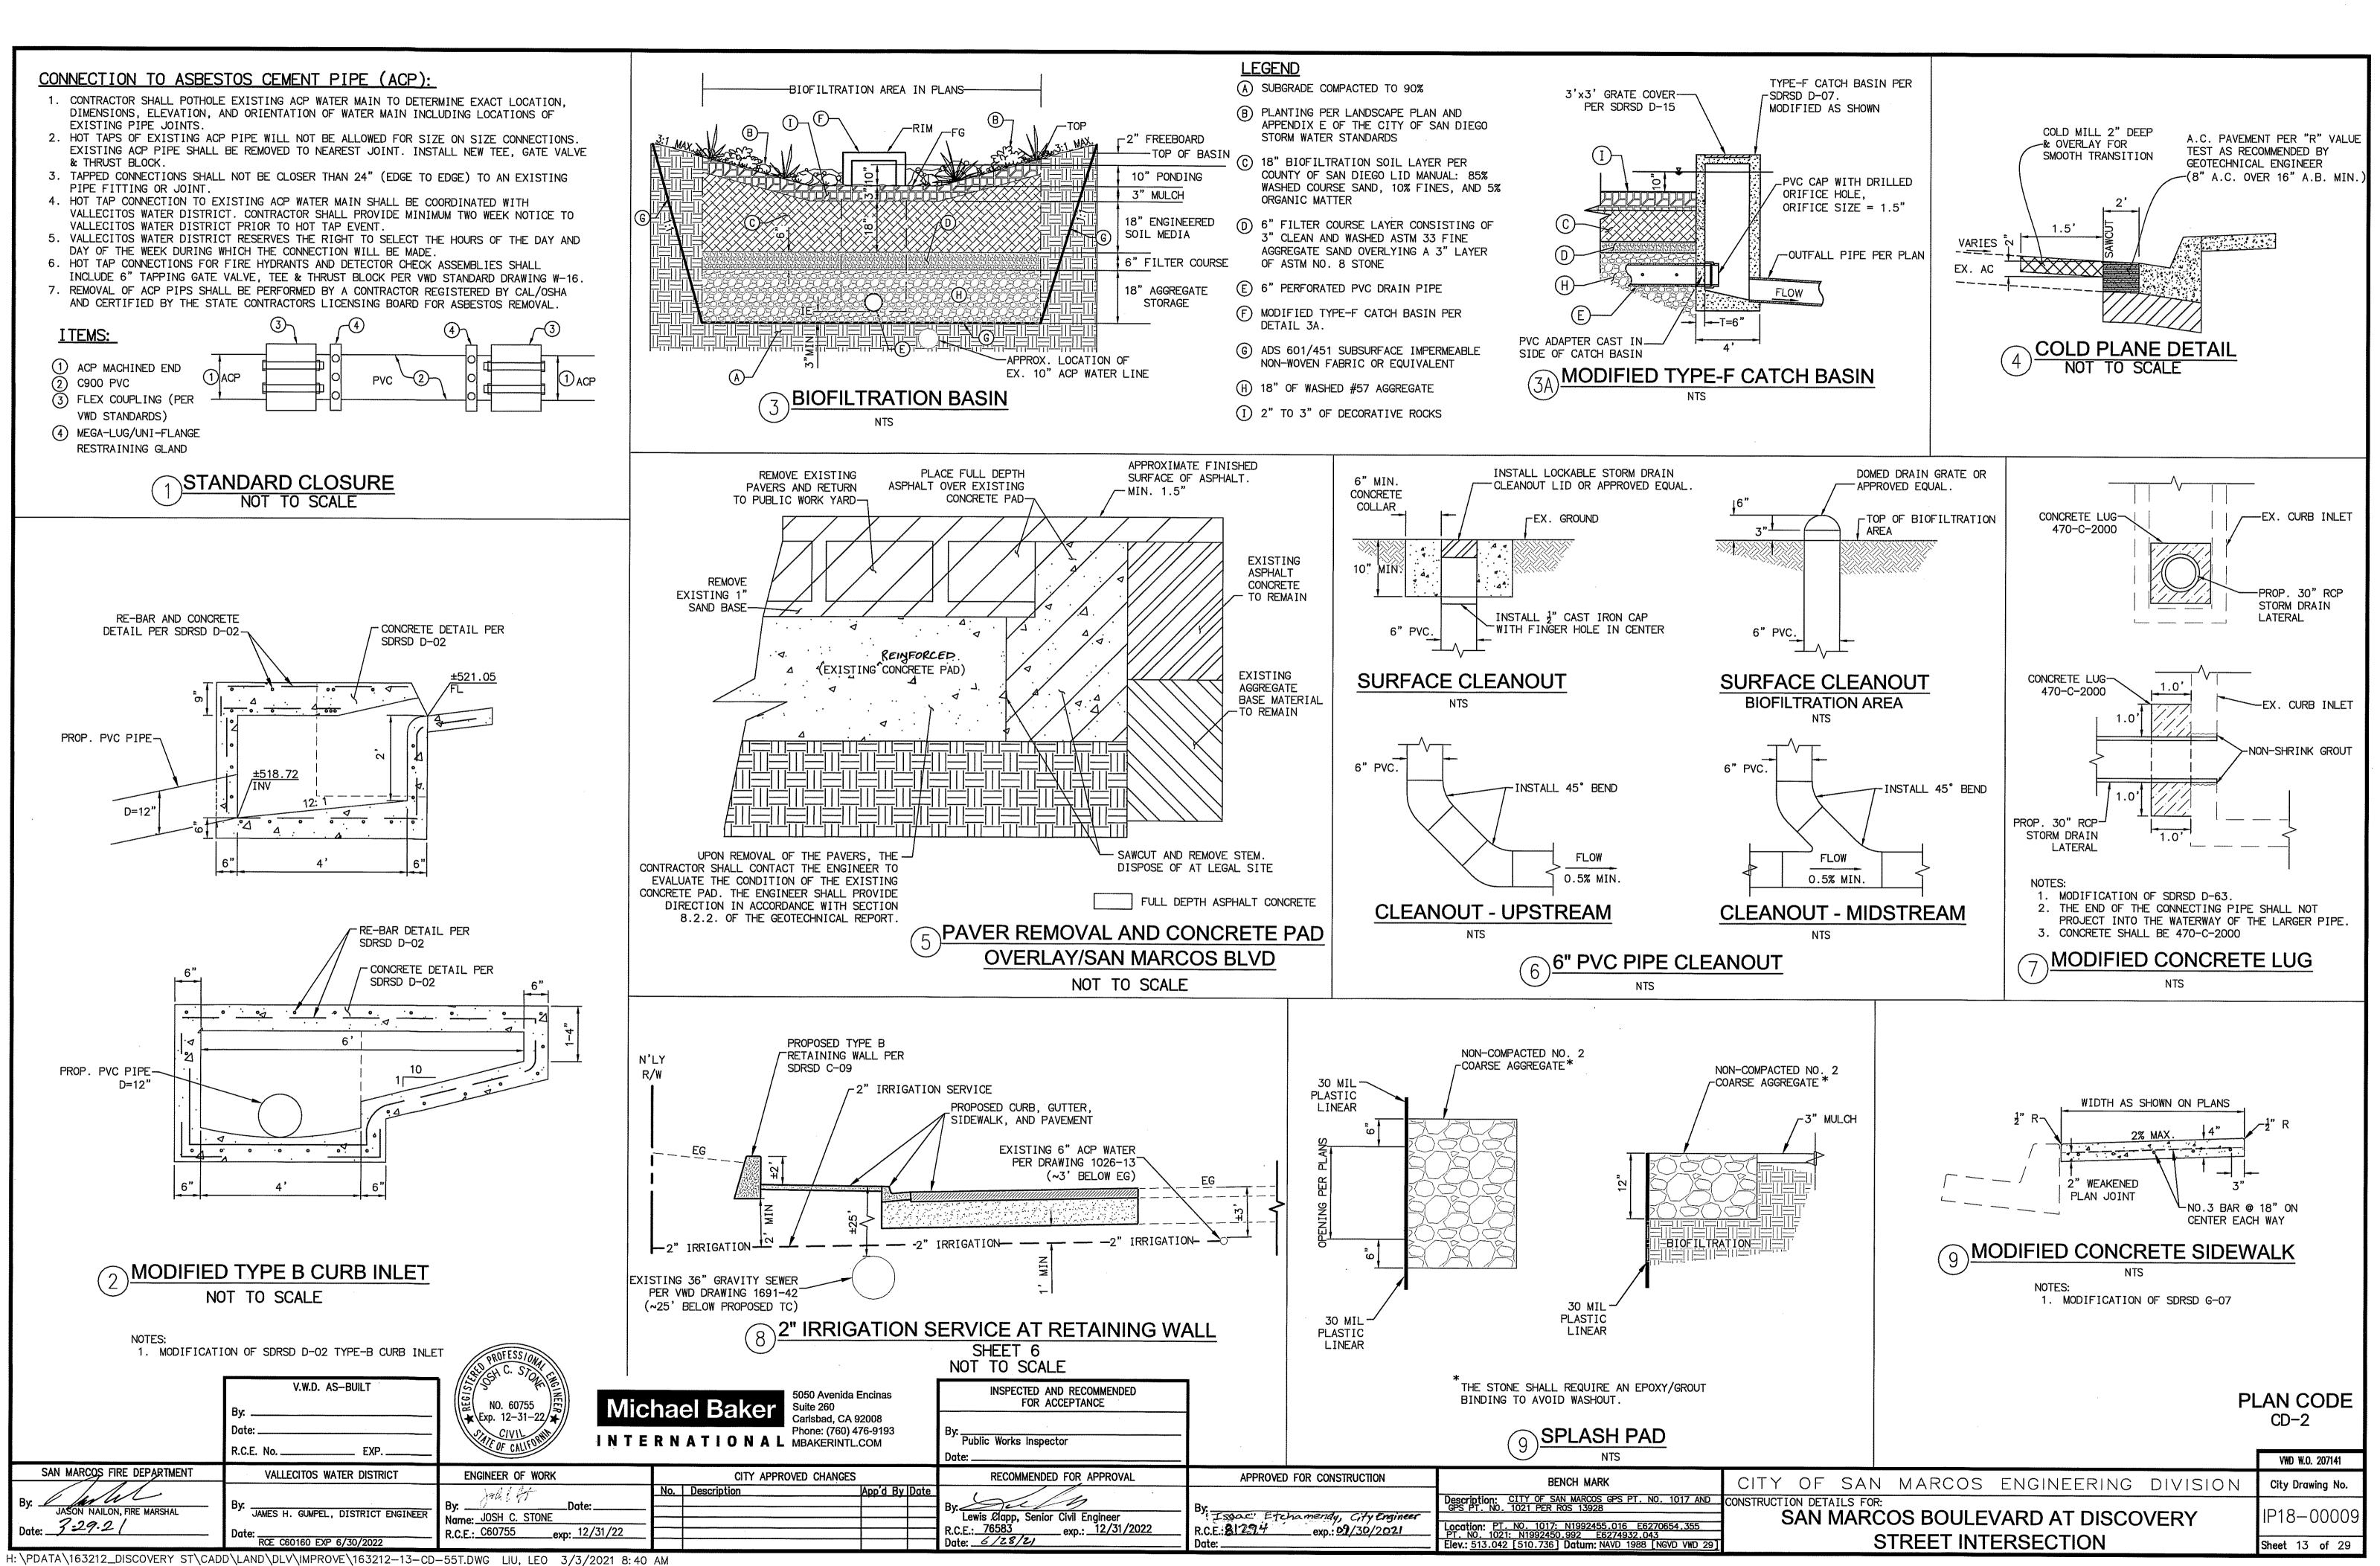

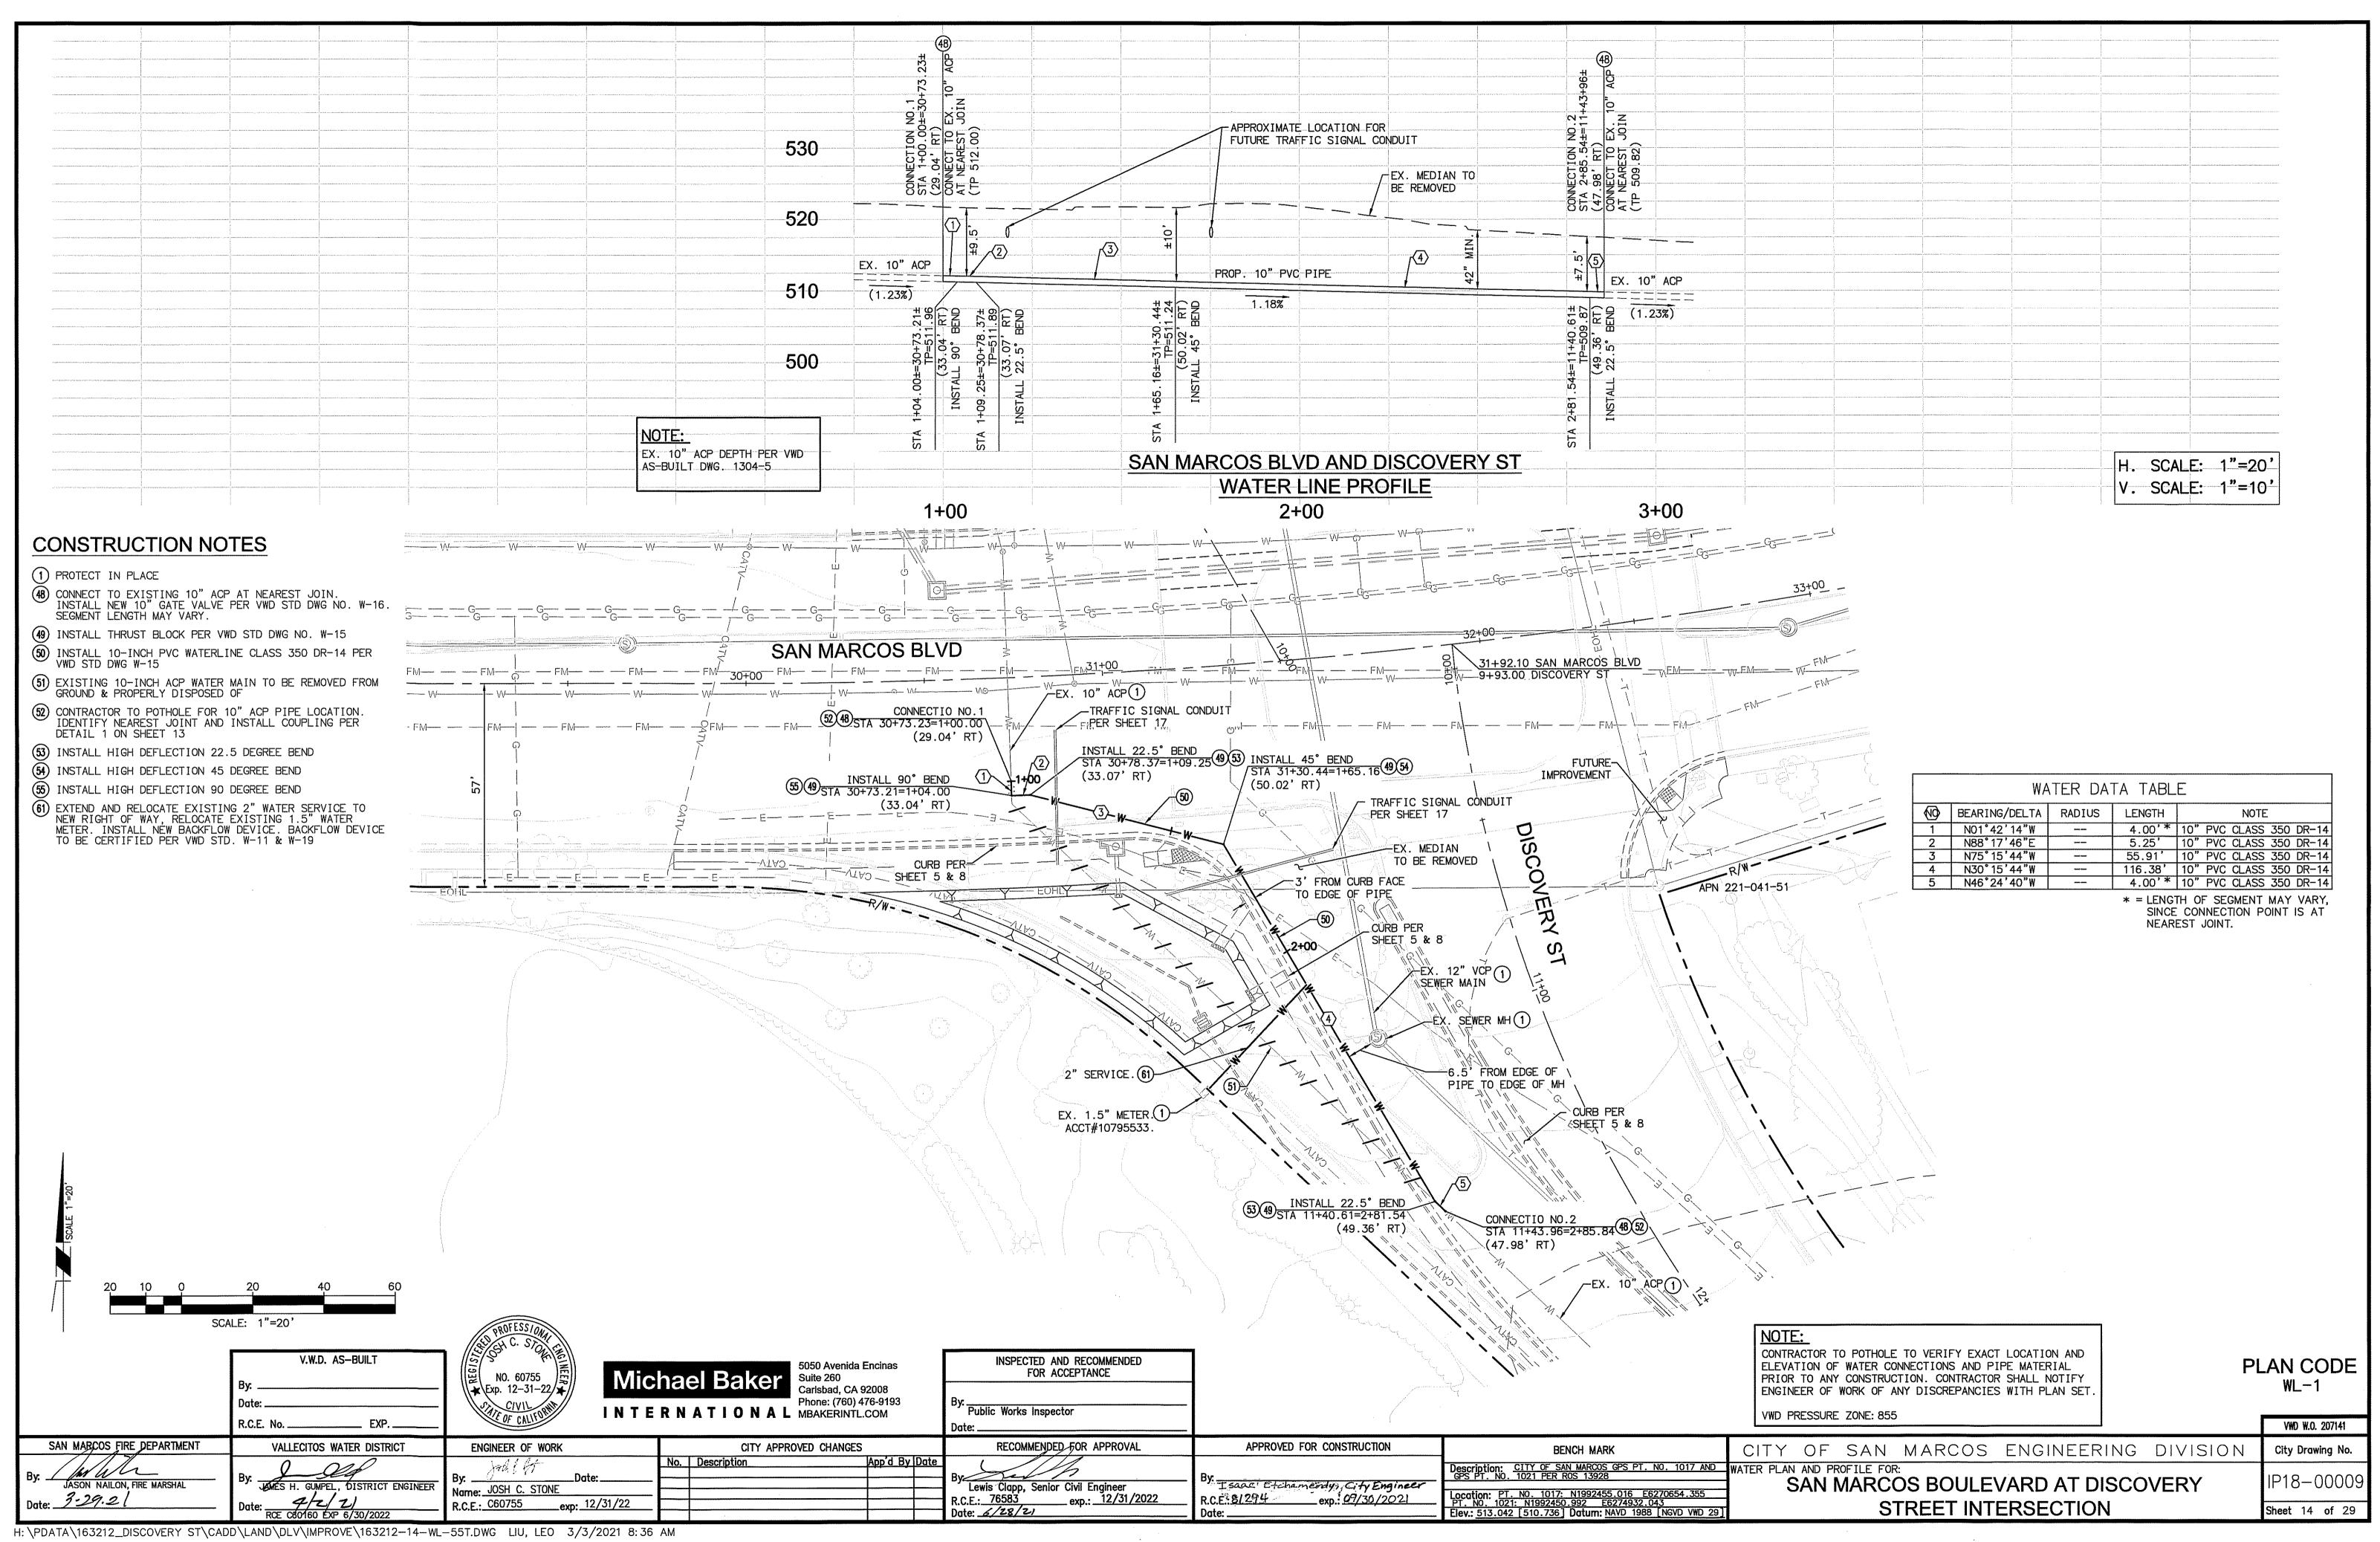

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GENERAL TRAFFIC NOTES:

- 1. A TRAFFIC CONTROL PLAN, INCLUDING THE LAYOUT OF CONSTRUCTION WARNING AND DETOUR SIGNS. SHALL BE SUBMITTED TO THE PUBLIC WORKS DEPARTMENT FOR APPROVAL A MINIMUM OF (14) CALENDAR DAYS PRIOR TO THE COMMENCEMENT OF CONSTRUCTION. TRAFFIC CONTROL SHALL BE IMPLEMENTED BEFORE ANY WORK IS
- 2. BEFORE EXCAVATING, THE CONTRACTOR SHALL VERIFY LOCATIONS OF UNDERGROUND FACILITIES OF THE FOLLOWING UTILITIES BY CONTRACTING THE UNDERGROUND SERVICE ALERT AT 1-800-227-2600:

SAN DIEGO GAS & ELECTRIC VALLECITOS WATER DISTRICT COX COMMUNICATIONS

TRAFFIC STRIPING NOTES:

- 1. ALL LETTER AND WORD PAVEMENT MARKING STENCILS USED WITHIN CITY LIMITS SHALL GENERALLY CONFORM TO THE CALTRANS "METRIC" SPECIFICATION, AS PROVIDED BY HAWKINS TRAFFIC SAFETY SUPPLY.
- 2. ALL ARROWS, WHETHER IN TURN LANCES, BIKE LANES OR OTHERWISE, SHALL CONFORM TO THE CALTRANS, "2015 STANDARD PLAN A24A" SPECIFICATION.
- 3. SYMBOLS AND NUMERALS: SYMBOLS AND NUMERALS SHALL CONFORM TO CALTRANS, "2015 STANDARD PLAN A24C" SPECIFICATION. THE CITY OF SAN MARCOS HAS DESIGNATED THE "BIKE LANE SYMBOL WITH PERSON" (FACING LEFT TO ROADWAY) TO BE USED IN ALL BIKE LANE APPLICATIONS. ALL OTHER BIKE LANE SYMBOLS SHALL BE EXCLUDED. ALL BIKE LANE SYMBOLS AND SPEED LIMIT LEGENDS SHALL BE PAINTED.
- 4. STRIPING ALIGNMENT AND LAYOUT, INCLUDING "TURKEY-TRACKS," SHALL BE THE RESPONSIBILITY OF THE CONTRACTOR AND IS SUBJECT TO THE CITY OF CAN MARCOS PUBLIC WORKS DEPARTMENT APPROVAL PRIOR TO FINAL INSTALLATION.
- 5. PAINT SHALL BE APPLIED UNDER SUITABLE WEATHER CONDITIONS AND PER THE PAINT MANUFACTURERS LABEL RECOMMENDATIONS FOR PAVEMENT AND AMBIENT TEMPERATURE REQUIREMENTS. PAINT SHALL NOT BE APPLIED IF RAIN IS FORECASTED WITHIN 24 HOURS.
- 6. THINNING OF PAINT WILL NOT BE ALLOWED.
- 7. SECTION 84-3.02 "MATERIALS" OF THE LATEST EDITION OF THE CALTRANS STANDARD SPECIFICATIONS IS AMENDED TO READ AS FOLLOWS:

PAINT FOR TRAFFIC STRIPES SHALL CONFORM TO THE FOLLOWING CALTRANS SPECIFICATIONS:

RAPID DRY WATER-BORNE, WHITE AND YELLOW 8010-42L-30 OR 8010-61G-10 [LOW VOC (VOLATILE ORGANIC COMPOUND) AND LEAD-BASED PAINTS ARE PROHIBITED].

GLASS BEADS SHALL CONFORM TO CALTRANS STANDARD SPECIFICATION NO.8010-51J-22 (TYPE 1-MOISTURE PROOF).

GLASS BEADS SHALL BE APPLIED WHEN STRIPING TRAFFIC LINES OR PAINTING LEGEND.

- INFORMATION REGARDING TRAFFIC PAINT AND GLASS BEADS MAY BE OBTAINED FROM THE CALTRANS ENGINEERING SERVICE CENTER, 5900 FOLSUM BLVD., SACRAMENTO, CA 95819-4612; (916)227-7000.
- 8. ALL STRIPING SHALL INCLUDE RAISED PAVEMENT MARKERS (RPMS) PER THE APPROPRIATE CALIFORNIA MANUAL ON UNIFORM TRAFFIC CONTROL DEVICES DETAILS.
- 9. RAISED PAVEMENT MARKERS (RPMS) SHALL BE CERAMIC OR ABS (ACRYLONITRILE-BUTADIENE-STYRENE) PLASTIC. APPROVED RPM TYPES ARE AS FOLLOWS:
- 9.a. TYPE A AND AY CERAMIC 4"ø (WHITE OR YELLOW);

9.b. 1 OR 2-WAY REFLECTIVE ABS - 4"X4" SQUARE. MINIMUM RPM THICKNESS SHALL BE 15 MILS.

RPMS SHALL BE AFFIXED WITH MACHINED APPLIED HOT BITUMEN OR STANDARD SET EPOXY (PART A AND B).

- 10. THE CONTRACTOR SHALL REMOVE ALL CONFLICTING PAINTED LINES. MARKINGS AND PAVEMENT LEGENDS BY SAND BLASTING WITHIN 24 HOURS OF CONFLICT. GRINDING MAY BE USED IF EQUIPMENT AND METHODOLOGY IS APPROVED BY THE CITY. SANDBLASTING OR GRINDING DEBRIS SHALL BE REMOVED AS SOON AS POSSIBLE BUT NO LATER THAN BEFORE THE END OF EACH WORK DAY. "BLACKING OUT" OF EXISTING STRIPING WILL NOT BE ALLOWED. WHERE TRAFFIC STRIPING OR PAVEMENT MARKINGS ARE TO BE REMOVED BY SANDBLASTING OR GRINDING, THE PAVEMENT SHALL ALSO BE PATCHED AND SLURRY SEALED (TYPE II SLURRY) AT THE DISCRETION OF THE CITY INSPECTOR. THE CONTRACTOR SHALL NOTIFY THE CITY OF SAN MARCOS' PUBLIC WORKS DEPARTMENT UPON COMPLETION OF STRIPING.
- 11. TWO COATS OF PAINT SHALL BE APPLIED ON NEW SURFACES AND ONE ON EXISTING SURFACES.
- 12. SIGNALIZED INTERSECTIONS SHALL HAVE MARKED PEDESTRIAN CROSSWALKS. ALL CROSSWALKS. LIMIT LINES, STOP BARS. PAVEMENT ARROWS. SCHOOL LEGENDS. AND PAVEMENT LEGENDS OTHER THAN BICYCLE LEGENDS/ARROWS SHALL BE INSTALLED WITH THERMOPLASTIC, UNLESS OTHERWISE NOTED ON THE PLAN. SPEED LIMIT LEGENDS SHALL BE INSTALLED WITH PAINT.
- 13. ALL NEW OR MODIFIED CROSSWALKS SHALL BE "CONTINENTAL" STYLE MARKED CROSSWALKS WITH A LIMIT BAR SETBACK OF 4-FEET MINIMUM.
- 14. A MINIMUM OF 100 FEET DOUBLE YELLOW CENTERLINE SHALL BE STRIPED ALONG ALL KNUCKLES AND HORIZONTAL CURVATURES WITH THE RADIUS OF 100 FEET OR LESS. RED CURB OR "NO PARKING ANYTIME" SIGNS SHALL BE INSTALLED ON THE INSIDE OF THE ROADWAY CURVATURE.
- 15. ALL CALTRANS DETAIL 40 AND DETAIL 41 WITHIN THE INTERSECTIONS SHALL BE INSTALLED WITH THERMOPLASTIC. UNLESS OTHERWISE NOTED ON THE PLANS.
- 16. U-TURNS SHALL BE RESTRICTED WHERE LESS THAN 44 FEET EXISTS BETWEEN THE RIGHT LANE LINE OF THE LEFT TURN LANE AND THE FACE OF CURB FOR THE OPPOSING DIRECTION OF TRAVEL FOR SINGLE LEFT TURN LANES. WHERE LESS THAN 36 FEET EXISTS BETWEEN THE LEFT EDGE OF THE INSIDE LEFT TURN LANE TO THE FACE OF CURB FOR THE OPPOSING DIRECTION OF TRAVEL FOR DUAL TURN LANES. OR AS REQUIRED BY THE CITY ENGINEER.
- 17. ROUNDABOUT SIGNAGE FOR ONE-LANE, TWO-LANE, AND MINI-ROUNDABOUT TYPES SHALL CONFORM TO CHAPTER 2B (REGULATORY SIGNS, BARRICADES AND GATES) OF THE 2014 CAMUTCD. ROUNDABOUT MARKINGS FOR ONE-LANE. TWO LANE, AND MINI-ROUNDABOUT TYPES SHALL CONFORM TO CHAPTER R3C (ROUNDABOUT MARKINGS) OF THE 2014 CAMUTCD.
- 18. IF IT IS NECESSARY OR DESIRABLE TO PROHIBIT CERTAIN PEDESTRIAN MOVEMENTS AT A TRAFFIC SIGNAL INTERSECTION, A PEDESTRIAN BARRIER SHALL BE INSTALLED TO PREVENT THE PEDESTRIAN MOVEMENTS. THE CONTRACTOR SHALL INSTALL A PEDESTRIAN BARRIER IN CONFORMANCE TO THE CITY OF SAN DIEGO PEDESTRIAN BARRICADE STANDARD (SDE-103). IF IT NOT PRACTICAL TO INSTALL SUCH A BARRIER, THEN THE "NO PEDESTRIAN CROSSING (R9-3) SIGNS SHALL BE USED.

V.W.D. AS-BUILT

Date: .

NO. 69470

★\Exp. 06-30-22/**★**/

TRAFFIC SIGNING NOTES:

1. SIGNING SHALL BE THE RESPONSIBILITY OF THE CONTRACTOR AND SHALL BE SUBJECT TO CITY OF SAN MARCOS PUBLIC WORKS DEPARTMENT APPROVAL. ALL SIGNS SHALL CONFORM TO THE CALIFORNIA MANUAL ON UNIFORM TRAFFIC CONTROL DEVICES, LATEST EDITION.

2. SIGN POSTS:

- 2.a. SHALL BE. TUBULAR BREAK-AWAY POSTS (TELSPAR OR UNISTRUT), 1 3/4" GALVANIZED STEEL OR EQUAL:
- 2.b. SHALL HAVE A SEVEN FEET (7') VERTICAL CLEARANCE ABOVE FINISHED GRADE FOR ONE SIGN MOUNTING OR SIX FEET (6') FOR A TWO SIGN MOUNTING:
- 2.c. SHALL HAVE A MAXIMUM OF TWO SIGNS (WITH DIFFERENT MEANINGS) ON EACH SIDE (MAXIMUM NUMBER OF SIGNS ON BOTH SIDES SHALL NOT EXCEED FOUR).
- 2.d. SHALL BE ANCHORED A MINIMUM OF TWENTY-FOUR INCHES (24") BELOW FINISHED GRADE IN UNDISTURBED SOIL AND BACKFILLED WITH NATIVE SOIL, DECOMPOSED GRANITE, OR SAND.
- 2.e. LOCATED IN THE MEDIAN, SHALL BE SET IN AN EIGHT INCH DIAMETER (8"0) BY TWENTY-FOUR INCH (24") DEEP PVC SLEEVE AND BACKFILLED WITH NATIVE SOIL, DECOMPOSED GRANITE, OR SAND TO THE TOP OF THE SLEEVE.
- 2.f. LOCATED IN THE SIDEWALK, A TEN-INCH DIAMETER CORE (10"ø) SHALL BE DRILLED. BACKFILL SHALL BE FOUR INCHES (4") OF CONCRETE ABOVE TWENTY INCHES (20") OF NATIVE SOIL. DECOMPOSED GRANITE, OR SAND.
- 2.q. SHALL BE NEW (USED POSTS ARE PROHIBITED ON NEW SIGN INSTALLATIONS); 2.h. SHALL BE REJECTED IF DAMAGED, BENT, OR SPLINTERED:
- 2.i. LOCATIONS SHALL BE MARKED BY CONTRACTOR AND APPROVED BY THE PUBLIC WORKS DIRECTOR OR HIS ASSIGNEE PRIOR TO FINAL PLACEMENT
- 2.i. SHALL HAVE A MINIMUM OF FORTY-EIGHT INCHES (48") HORIZONTAL DISTANCE BETWEEN POST AND BACK EDGE OF SIDEWALK (ADA SPECIFICATION) FOR WHEEL CHAIR ACCESS.
- 2.k. SHALL BE 2-7/8" ALUMINUM POSTS FOR STREET NAME SIGNS AND STOP (R1-1) SIGNS. 2.I. SHALL BE WRAPPED WITH GORILLA TAPE AROUND BASE OF BREAKAWAY POST BELOW SUBGRADE.
- *** WOOD POSTS USED FOR CLASS II OR III BARRICADES SHALL BE PAINTED WHITE.
- 3.a. SHALL BE ALUMINUM AND HAVE REFLECTIVITY FACING AND MESSAGE WITH A HIGH INTENSITY DESIGN OR BETTER:
- 3.b. SHALL HAVE A MINIMUM OF TWELVE INCHES (12") HORIZONTAL CLEARANCE BEHIND THE CURB
- 3.c. THIRTY-SIX INCHES (36") WIDE SHALL BE STRAPPED ON THE BACK OF THE SIGN WITH SIGN
- 3.d. LARGER THAN THIRTY-SIX INCHES (36") WIDE SHALL BE SET ON TWO POSTS;
- 3.e. SHALL BE MOUNTED ON: 3.e.1. NEW OR EXISTING STREET LIGHT STANDARDS SHALL USE A 5/8-INCH" "BAND IT" STEEL
- STRAPPING WITH FASTENERS: 3.e.2. ALUMINUM POSTS SHALL USE 2 7/8" POST CAPS FOR SINGLE SIGNS AND 2 7/8" CROSS
- SADDLE FOR TWO SIGNS: 3.f. MOUNTED ON POWER/UTILITY POLE IS PROHIBITED.
- 4. STREET NAME SIGNS SHALL HAVE 9-INCH EXTRUDED ALUMINUM BLADES, HIGH INTENSITY SHEETING WITH 3M BLUE ELECTROCUT FILM. 6-INCH HIGHWAY GOTHIC LETTERING WITH FIRST LETTER IN CAPITALS AND THE REST LOWER CASE, BLOCK ADDRESS, AND ROAD DESIGNATIONS.
- 5. WHERE AN R4-7 SIGN AND OM1-3 OBJECT MARKER SIGN ARE TO BE INSTALLED IN A MEDIAN WIDTH LESS THAN 42-INCHES, THE R4-7 SIGN SHALL BE MOUNTED 7-FEET VERTICALLY FROM THE EXISTING GROUND SURFACE. THE R4-7 SIGN SHALL BE 18" X 24" AND THE OM1-3 OBJECT MARKER SHALL BE 18" X 18". OM2-1H SHALL BE INSTALLED BEHIND OM1-3.
- WHERE AN R6-1 SIGN ("ONE WAY") SIGN IS TO BE INSTALLED IN A MEDIAN ISLAND, THE R6-1 SIGN SHALL BE MOUNTED 18-INCHES VERTICALLY FROM THE EXISTING GROUND. IF A LANDSCAPED PLANTER IS PRESENT AND VEGETATION INTERFERES WITH SIGN LOCATION, THE R6-1 SIGN SHALL BE MOUNTED 4-FEET VERTICALLY FROM THE EXISTING GROUND.
- 7. THE CONTRACTOR SHALL NOTIFY THE CITY OF SAN MARCOS' PUBLIC WORKS DEPARTMENT UPON COMPLETION OF SIGNING.
- 8. EXISTING SIGNS SHALL BE SALVAGED AND DELIVERED TO THE PUBLIC WORKS DEPARTMENT LOCATED AT 201 MATA WAY.
- 9. STOP SIGN INSTALLATION SHALL INCLUDE THE SIGN, POST, STOP BAR, STOP LEGEND AND A MINIMUM OF 50' OF DOUBLE YELLOW CENTERLINE STRIPING UNLESS ADJACENT TO MEDIAN.
- 10. NO OUTLET SIGNS SHALL BE POSTED WHERE THERE IS NO LEGAL OUTLET WHEN THE STREET EXCEEDS 800 FEET OR WHEN THE TERMINUS OF THE ROADWAY IS NOT VISIBLE FROM THE INTERSECTION.

5050 Avenida Encinas

Phone: (760) 476-9193

Carlsbad, CA 92008

11. FLUORESCENT YELLOW GREEN (FYG) BACKGROUND COLORED SIGNS SHALL BE INSTALLED FOR ALL SCHOOL AREA SIGNS PER THE CALIFORNIA MANUAL ON UNIFORM TRAFFIC CONTROL DEVICES (MUTCD).

TRAFFIC SIGNAL GENERAL NOTES:

- 1. THE LOCATION OF ALL EXISTING UNDERGROUND UTILITIES IS APPROXIMATE. THE CONTRACTOR SHALL DETERMINE THE LOCATION AND DEPTH OF ALL UTILITIES INCLUDING THOSE NOT SHOWN ON THESE PLANS. VERIFICATION OF THE LOCATION AND DEPTH OF UNDERGROUND UTILITIES AND DIGGING FOR FOUNDATIONS SHALL BE DONE BY HAND EXCAVATION METHODS UNTIL CLEAR OF ALL UNDERGROUND FACILITIES. ALL UNDERGROUND UTILITIES SHALL BE PROTECTED DURING CONSTRUCTION AND EXPENSE OF REPAIR OR REPLACEMENT OF UTILITIES DAMAGED DURING CONSTRUCTION SHALL BE BORNE BY THE CONTRACTOR.
- 2. THE CONTRACTOR SHALL OBTAIN ALL NECESSARY PERMITS AND NOTIFY ALL UTILITIES, AGENCIES AND THE CITY OF SAN MARCOS (760) 752-7550 AT LEAST 48 HOURS IN ADVANCE OF

BEFORE EXCAVATION, THE CONTRACTOR SHALL VERIFY LOCATIONS OF UNDERGROUND FACILITIES OF THE FOLLOWING UTILITIES BY CONTACTING THE UNDERGROUND SERVICE ALERT AT 1-800-277-2600:

- AT&T PACIFIC BELL
- SAN DIEGO GAS & ELECTRIC
- VALLECITOS WATER DISTRICT
- COX COMMUNICATIONS
- UTILITY MARK-OUTS SHALL BE CONDUCTED USING A TEMPORARY PAINT THAT CAN BE REMOVED BY POWER WASH, IF NECESSARY. ADD TO THE PLANS "THE CONTRACTOR SHALL REMOVE ALL MARK OUT PAINT UPON COMPLETION OF THE WORK.
- 3. ALL PROPERTY CORNER MONUMENTS SHALL BE UNDISTURBED BY CONSTRUCTION OR IMPROVEMENTS. DISTURBED MONUMENTS SHALL BE RESET OR REPLACED BY A LICENSED LAND SURVEYOR OR REGISTERED CIVIL ENGINEER AUTHORIZED TO SET MONUMENTS
- 4. POLE, DETECTOR, AND EQUIPMENT LOCATIONS ARE APPROXIMATE. THE CITY OF SAN MARCOS' ENGINEERING DEPARTMENT INSPECTORS/TRAFFIC SIGNAL LIGHTING SUPERVISOR SHALL FIELD VERIFY AND APPROVE THE EXACT EQUIPMENT LOCATIONS PRIOR TO INSTALLATION.
- 5. THE CONTRACTOR SHALL PROVIDE ALL NECESSARY TRAFFIC CONTROL DEVICES DURING TRAFFIC SIGNAL INSTALLATION. A TRAFFIC CONTROL PLAN, INCLUDING THE LAYOUT OF CONSTRUCTION WARNING AND DETOUR SIGNS, WORKING HOURS, AND CONSTRUCTION SCHEDULE SHALL BE SUBMITTED TO THE ENGINEERING DIVISION DEPARTMENT FOR APPROVAL A MINIMUM OF FIVE DAYS PRIOR TO THE COMMENCEMENT OF CONSTRUCTION. TRAFFIC CONTROL SHALL BE IMPLEMENTED BEFORE ANY WORK IS STARTED
- 6. ALL TRAFFIC SIGNAL CONDUIT AND FITTINGS (AFTER THE ELECTRIC METER PEDESTAL) SHALL BE MINIMUM THREE INCH (3") SCHEDULE 80 PVC. STREET CROSSINGS SHALL BE FOUR INCHES (4") MINIMUM, ENCASED IN A MINIMUM OF TWELVE INCHES (12") OF 560-C-3250 PSI CONCRETE (8" MINIMUM CONCRETE COVER TO TOP OF PIPE). ALL CONDUITS SHALL BE BURIED WITH A MINIMUM OF THIRTY INCHES (30") OF TOTAL COVER FROM THE TOP OF PIPE TO FINISHED GRADE. ALL CONDUITS SHALL BE SEALED UPON COMPLETION. STREET CROSSINGS BY BORE METHOD SHALL BE APPROVED BY THE CITY ENGINEER. ALL DIRECTIONAL BORED RACEWAYS SHALL BE HDPE TYPICAL
- 7. ALL SIGNAL CONDUCTORS, COMMUNICATION CABLES, AND OTHER ASSOCIATED WIRING SHALL BE LABELED (WITH THE BROTHER P-TOUCH WATERPROOF LABELS OR CITY APPROVED EQUAL) IN THE CABINET WITH ASSOCIATED ASSIGNMENTS (LANE, PHASES, CHANNEL NUMBERS, AND COMMUNICATION FUNCTIONS).
- 8. CURB RAMPS SHALL BE INSTALLED AT ALL CURB RETURNS PER TITLE 24, PART 2, STATE CHAPTER 71, SITE DEVELOPMENT REQUIREMENTS FOR HANDICAPPED ACCESSIBILITY, SECTION 7103, CURB RAMPS OF THE CALIFORNIA BUILDING CODE, AND SHALL INCLUDE TRUNCATED DOMES (TYPE AND COLOR AS DIRECTED BY THE ENGINEER)
- 9. ALL TRENCH EXCAVATION AND BACKFILL IN THE PUBLIC RIGHT-OF-WAY SHALL CONFORM TO THE REQUIREMENTS OF THE CITY OF SAN MARCOS' EXCAVATION ORDINANCE. MINIMUM 95% COMPACTION IS REQUIRED IN ALL ON-SITE FILL AREAS WITHIN ULTIMATE RIGHT-OF-WAY.
- 10. A NEW SLURRY COAT OR OVERLAY SHALL BE APPLIED A MINIMUM OF 20 FEET EITHER SIDE OF PATCH WORK RESULTING FROM EXCAVATION WORK (TRENCHING AND POTHOLING) ON NEW STREETS (SLURRY COATED WITHIN LAST THREE YEARS) OR STREET WITH CLEAN AND UNIFORM PAVEMENT. THE DETERMINATION OF EXISTING PAVEMENT CONDITION SHALL BE MADE BY THE ENGINEERING DIVISION INSPECTOR.
- 11. THE CONTRACTOR SHALL BE RESPONSIBLE FOR SERVICE COORDINATION WITH THE S.D.G.&E. SERVICE ORDER INFORMATION WILL BE PROVIDED TO THE CONTRACTOR BY THE CITY
- 12. EXISTING TRAFFIC SIGNAL FACILITIES, SIGNALS, AND COMMUNICATIONS SHALL REMAIN OPERATIONAL UNTIL NEW FACILITIES ARE CUTOVER OR CONNECTED OR AS LONG AS APPROVED BY THE PROJECT INSPECTOR. THE CONTRACTOR SHALL BE RESPONSIBLE FOR INSTALLATION, MAINTENANCE, AND REMOVAL OF ANY TEMPORARY WIRING NECESSARY TO MAINTAIN SIGNAL OPERATIONAL DURING CONSTRUCTION.
- 13. LUMINAIRES SHALL CONFORM TO LATEST CITY OF SAN MARCOS STREET LIGHTING STANDARDS.
- 14. THE CONTRACTOR SHALL BE RESPONSIBLE FOR THE INSTALLATION, RELOCATION, OR REPLACEMENT OF ALL STRIPING AND SIGNING AS REQUIRED BY THE TRAFFIC ENGINEER. ALL SIGNS SHALL CONFORM TO THE CALIFORNIA MANUAL OF UNIFORM TRAFFIC CONTROL DEVICES (CAMUTCD) AND CITY OF SAN MARCOS SIGNING AND STRIPING STANDARDS.
- 15. AN "AS-BUILT" DRAWING SHALL BE SUBMITTED FOR ALL PUBLIC IMPROVEMENTS PRIOR TO THE ACCEPTANCE OF SAID IMPROVEMENTS.
- 16. THESE PLANS HAVE BEEN EXAMINED BY THE CITY OF SAN MARCOS ENGINEERING DIVISION TO INSURE COMPLIANCE WITH GENERAL ENGINEERING STANDARDS AND THE CITY'S DESIGN STANDARDS AND SPECIFICATIONS. THE ENGINEER-OF-WORK SHALL BEAR THE SOLE RESPONSIBILITY OF THE MATHEMATICAL DATA AND ACCURACY OF DESIGN SHOWN HERE ON.
- 17. TRAFFIC SIGNAL CONSTRUCTION SHALL NOT COMMENCE UNTIL ALL MATERIALS INCLUDING POLES, MAST ARMS, AND CONTROLLER ARE ON-HAND UNLESS APPROVED BY THE PROJECT INSPECTOR.
- 18. THE CONTRACTOR SHALL BE RESPONSIBLE FOR THE INSTALLATION, RELOCATION, OR REPLACEMENT OF ALL TRAFFIC LOOP DETECTORS AS REQUIRED BY THE TRAFFIC ENGINEER WITHIN 48 HOURS OF DIRECTION, OR INSTALL TEMPORARY VIDEO DETECTION UNTIL LOOP DETECTOR WORK IS COMPLETED. EXISTING TRAFFIC SIGNAL DETECTOR LOOPS DAMAGED DURING CONSTRUCTION SHALL BE REPLACED WITHIN 48 HOURS OF DATE AND TIME DAMAGED OR TEMPORARY VIDEO DETECTION SHALL BE INSTALLED UNTIL THE DAMAGED LOOPS ARE REPLACED.
- 19. WHEN PERFORMING A TRAFFIC SIGNAL MODIFICATION WORK, THE CONTRACTOR SHALL BE RESPONSIBLE FOR ENSURING CONTINUED OPERATION OF THE TRAFFIC SIGNAL THROUGHOUT THE PROJECT. IF ANY DAMAGES OCCUR, THE CONTRACTOR SHALL RESPOND WITHIN 3 HOURS AND RESTORE THE OPERATION WITHIN 48 HOURS.

"AS - BUILT" DECLARATION

AS ENGINEER-OF-WORK, I HEREBY CERTIFY THAT, TO THE BEST OF MY KNOWLEDGE AND BELIEF. THE IMPROVEMENTS SHOWN ON THIS SET OF CONSTRUCTION PLANS, SHEET 15 TO 17, HAVE BEEN INSTALLED AND CONSTRUCTED IN SUBSTANTIAL CONFORMANCE WITH THESE AS-BUILT PLANS, INCLUDING ALL APPROPRIATE STANDARDS AND ANY DISCRETIONARY APPROVAL(S) FOR THE PROJECT.


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PRINTED NAME	P.E.	NO	
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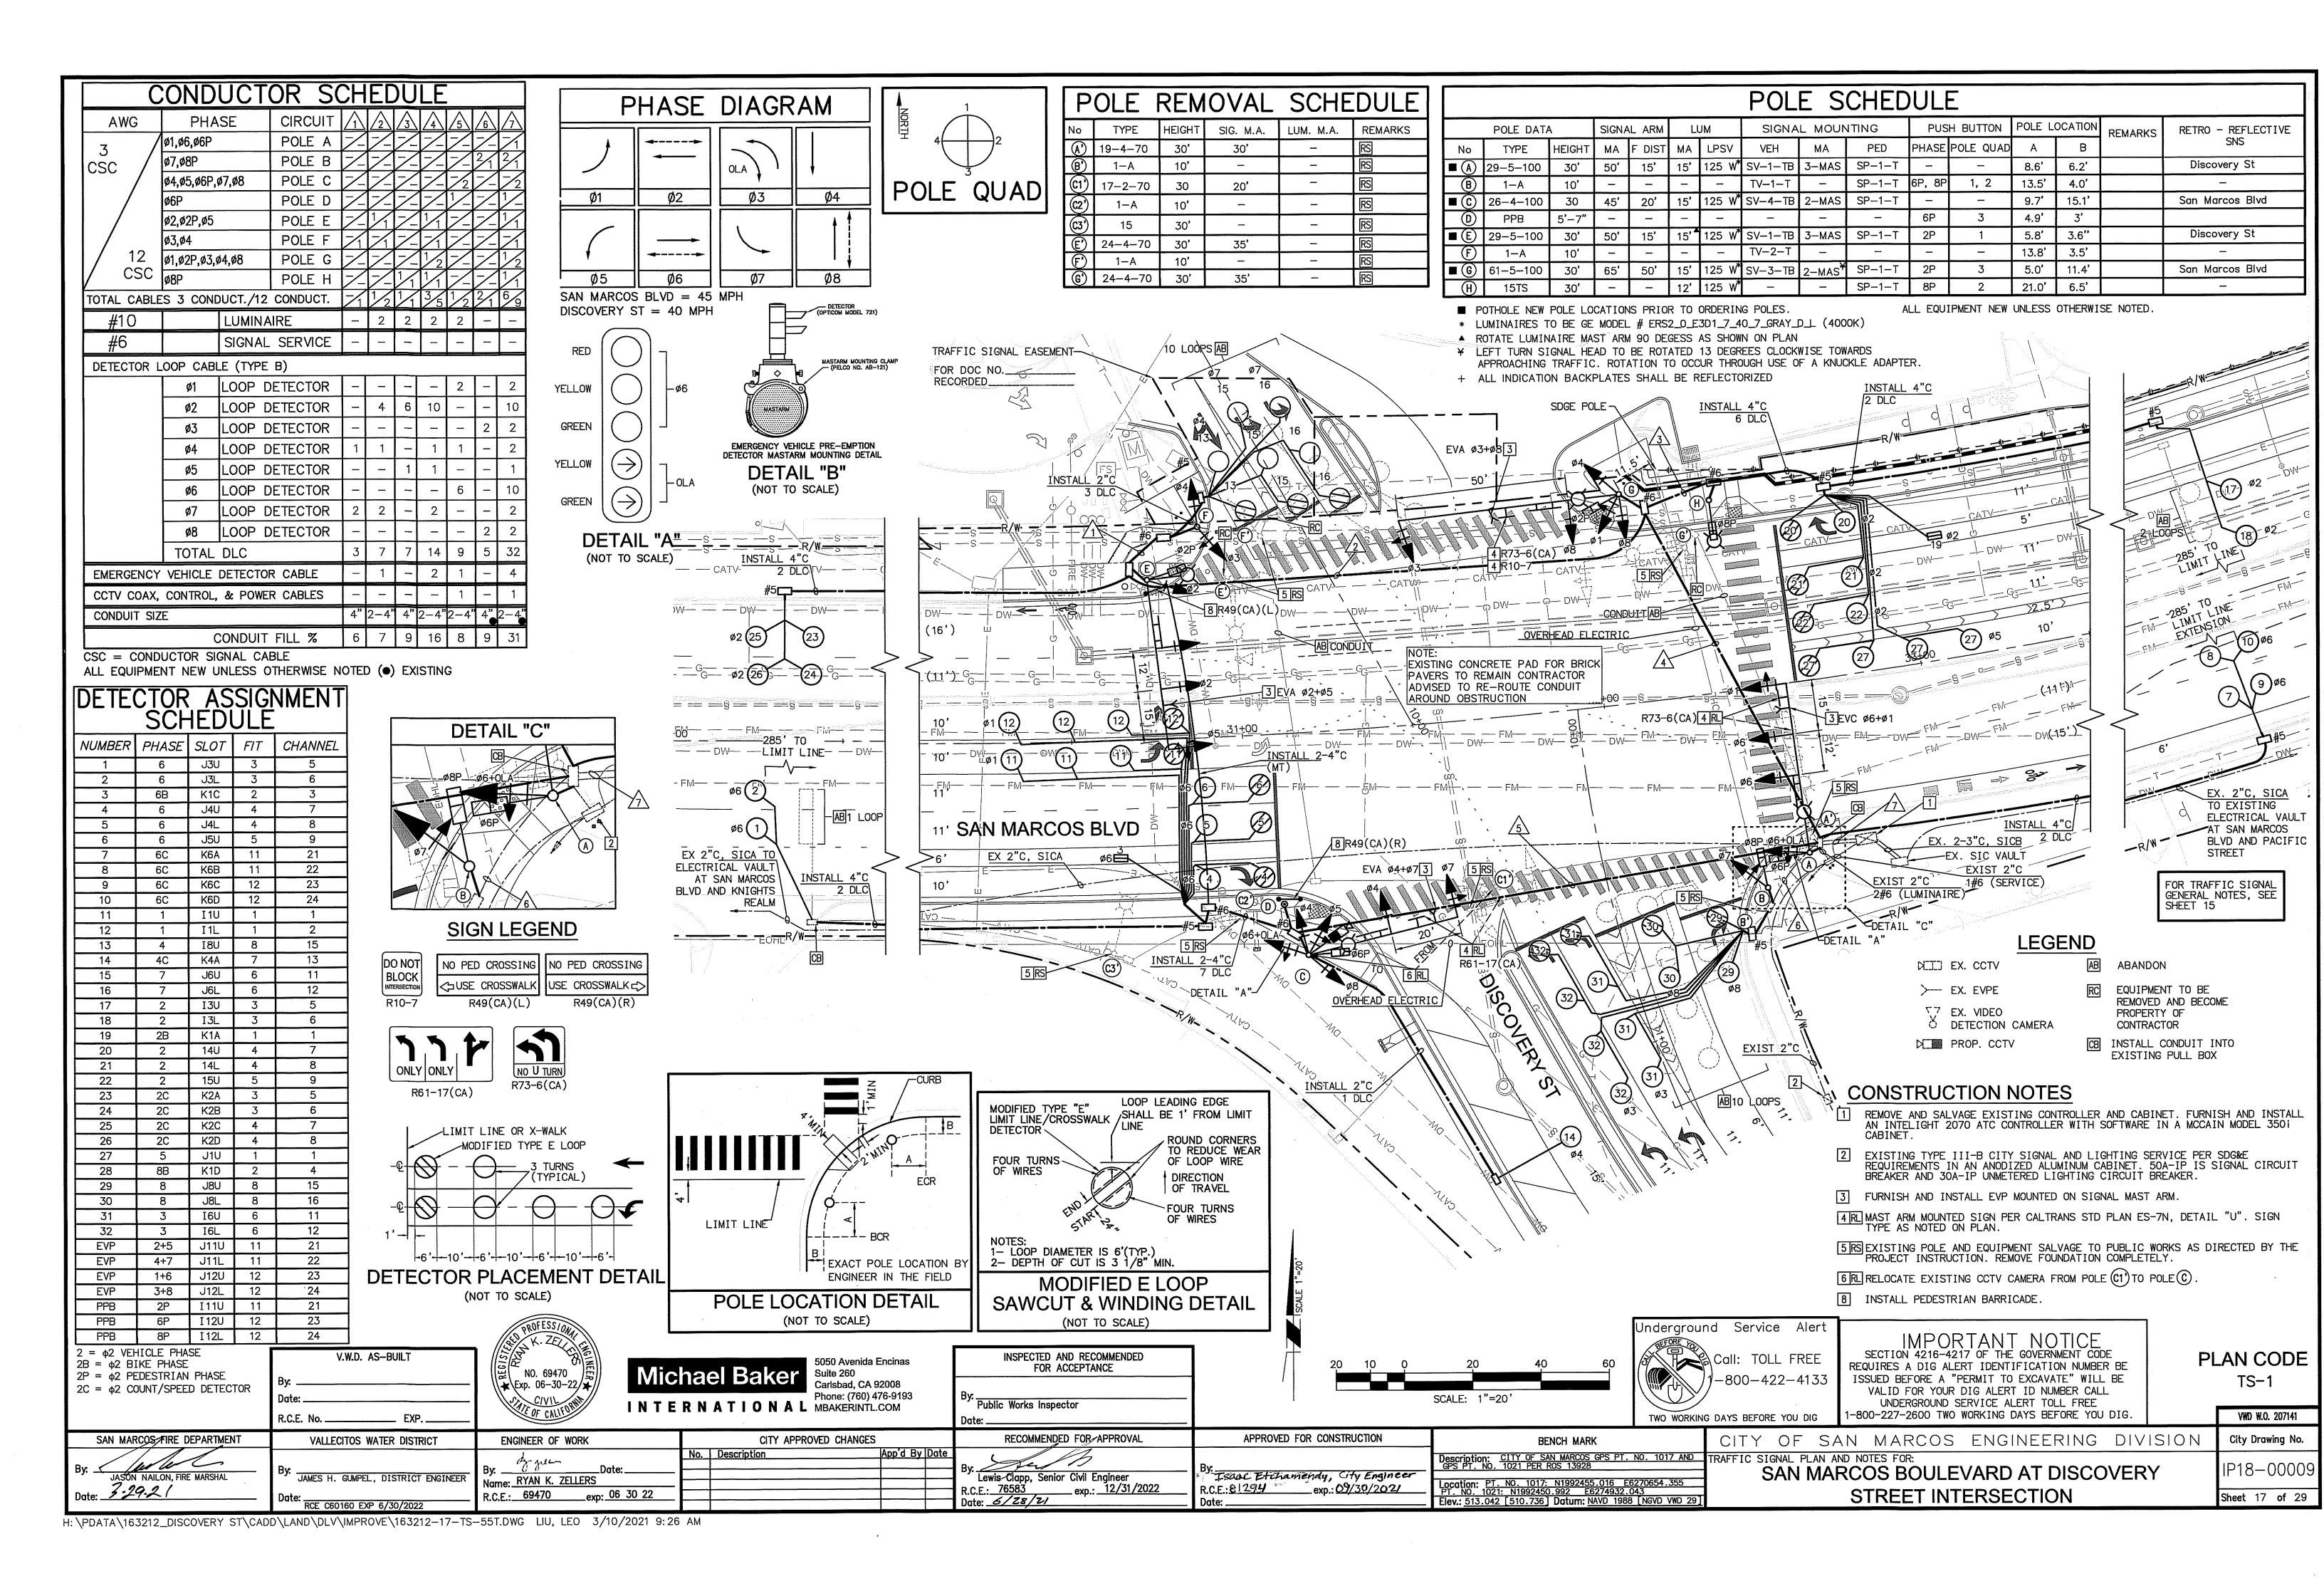
PLAN CODE SS-1

	R.C.E. No EXP	INT	ERNATIONAL MBAKERINTL.COM	Public Works Inspector	DISCIPLINE	MY REGISTRATION EXPIRES	_	
SAN MARCOS FIRE DEPARTMENT	VALLECITOS WATER DISTRICT	ENGINEER OF WORK	CITY APPROVED CHANGES	RECOMMENDED FOR APPROVAL	ADDROLED FOR CONCERNATION			VWD W.O. 207141
		de la la	No. Description App'd By Date		APPROVED FOR CONSTRUCTION	BENCH MARK	CITY OF SAN MARCOS ENGINEERING DIVISION	City Drawing No.
By: JASON NAILON, FIRE MARSHAL	By: JAMES H. GUMPEL, DISTRICT ENGINEER	By:Date:		By:	By:	Description: CITY OF SAN MARCOS GPS PT. NO. 1017 AND GPS PT. NO. 1021 PER ROS 13928	SIGNING AND STRIPING PLAN FOR:	
Date: 1-29-21	Date:	Name: RYAN K. ZELLERS R.C.E.: 69470exp; 06 30 22		Lewis Clapp, Senior Civil Engineer	Isaac Etchainendy, City Engineer	Location: PT. NO. 1017: N1992455.016 F6270654.355	SAN MARCOS BOULEVARD AT DISCOVERY	IP18-0000
	RCE C60160 EXP 6/30/2022			Date: 6/28/21	Pate:	PT. NO. 1021: N1992450.992 E6274932.043 Elev.: 513.042 [510.736] Datum: NAVD 1988 [NGVD VWD 29]	STREET INTERSECTION	Ch1 15 00
\PDATA\163212_DISCOVERY ST\CAD	DD\LAND\DLV\IMPROVE\163212-15-SS	-55T.DWG LIU, LEO 3/3/2021 10:0	09 AM			LOW CICHOL COLORED Details with 1000 (NOTE THE 25)	OTTLET HATEROLOTION	Sheet 15 of 29

INSPECTED AND RECOMMENDED

FOR ACCEPTANCE



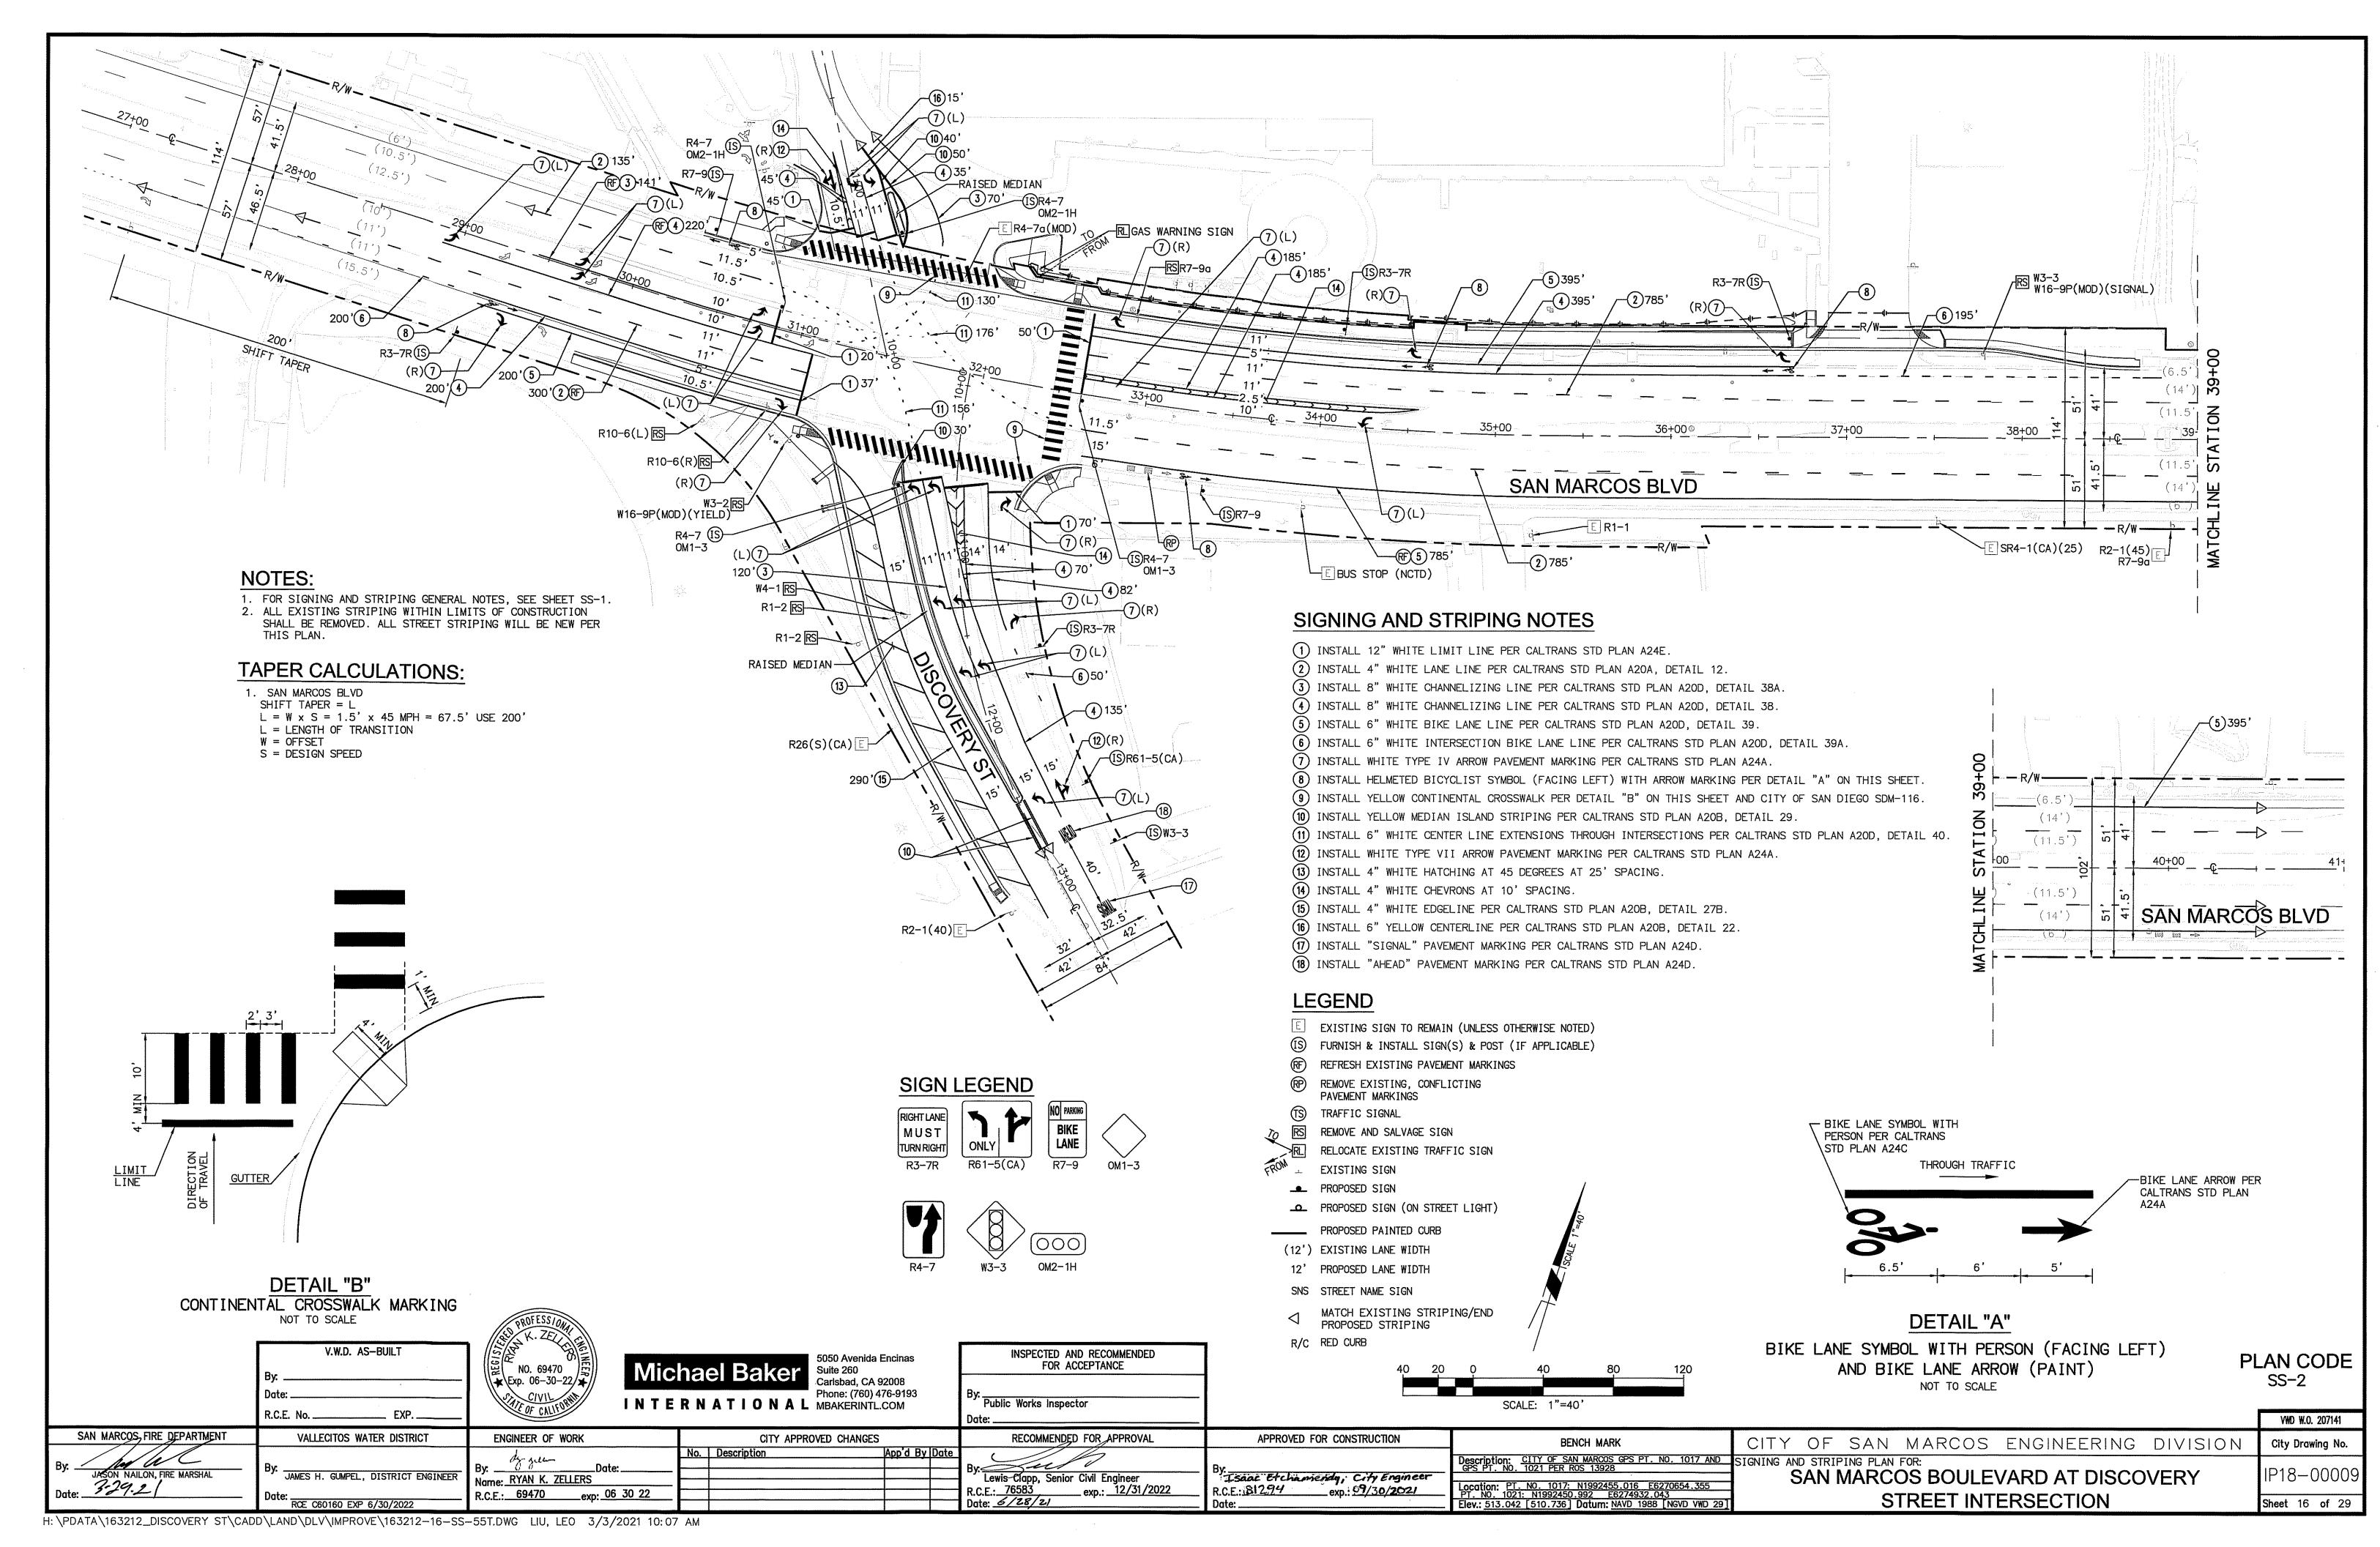

EROSION AND SEDIMENT CONTROL NOTES

- 1. THE CONTRACTOR, PERMITTEE, OR OWNER SHALL BE RESPONSIBLE FOR CONTINUAL MAINTENANCE OF THE EROSION CONTROL CONSTRUCTION.
- 2. ALL LOOSE SOIL AND DEBRIS SHALL BE REMOVED FROM THE STREET AREAS UPON STARTING OPERATIONS AND PERIODICALLY AFTER AS DIRECTED BY THE INSPECTOR
- 3. EMERGENCY WORK MAY BE NECESSARY DURING RAINSTORMS, CONSIDER THE AVAILABILITY OF STAND-BY WORK CREWS.
- 4. ALL REMOVABLE PROTECTION DEVICES SHOWN SHALL BE IN PLACE AT THE END OF EACH WORKING DAY AND DURING CONSTRUCTION WHEN RAIN IS OCCURRING.
- 5. EFFECTIVE PLANTING SHALL BE INSTALLED, FULLY GERMINATED, AND SHALL EFFECTIVELY COVER 70% OF THE AREAS OF DISTURBED VEGETATION PRIOR TO FILING OF THE NOTICE OF TERMINATION
- 6. GRAVEL BAGS AND NECESSARY MATERIALS SHALL BE AVAILABLE ON SITE AND STOCKPILED AT CONVENIENT LOCATIONS TO FACILITATE RAPID CONSTRUCTION OF TEMPORARY DEVICES OR TO REPAIR ANY DAMAGED EROSION CONTROL MEASURES WHEN RAIN IS EMINENT.
- 7. THE CONTRACTOR SHALL ONLY GRADE, INCLUDING CLEARING AND GRUBBING FOR THE AREAS FOR WHICH THE CONTRACTOR OR QUALIFIED PERSON CAN PROVIDE EROSION/SEDIMENT CONTROL MEASURES.
- 8. THE CONTRACTOR SHALL RESTORE ALL EROSION CONTROL DEVICES TO WORKING ORDER TO THE SATISFACTION OF THE QSP AFTER EACH RAIN
- 9. THE CONTRACTOR SHALL INSTALL ADDITIONAL EROSION CONTROL MEASURES DUE TO UNCOMPLETED GRADING OPERATIONS OR UNFORESEEN CIRCUMSTANCES WHICH MAY ARISE.
- 10. TEMPORARY EROSION AND SEDIMENT CONTROL DEVICES SHOWN ON THE EROSION AND SEDIMENT CONTROL PLAN WHICH INTERFERE WITH THE WORK SHALL BE RELOCATED OR MODIFIED (TEMPORARILY) AS THE WORK PROGRESSES, AS RECOMMENDED BY THE QSP.
- 11. PROVIDE VELOCITY CHECK DAMS IN ALL UNPAVED GRADED CHANNELS AT THE INTERVALS INDICATED BELOW UNLESS CHANNELS ARE LINED WITH TEMPORARY MATERIALS SUCH AS PLASTIC SHEETING.

GRADE OF CHANNEL	INTERVAL
LESS THAN 3%	100 FEET
3% - 6%	50 FEET
OVER 6%	25 FEET

- 12. A GRAVEL BAG SILT TRAP SHALL BE PROVIDED AT EVERY STORM DRAIN INLET TO PREVENT SEDIMENT FROM ENTERING THE STORM DRAIN SYSTEM
- 13. THE CONTRACTOR SHALL REMOVE SILT AND DEBRIS AFTER EACH MAJOR RAINFALL, OR WHEN SILT REACHES AN ELEVATION OF 0.5' BELOW WEIR OPENING FOR GRAVEL BAGS.
- 14. ALL EROSION CONTROL MEASURES PROVIDED PER THE APPROVED SWPPP SHALL BE INCORPORATED HEREON.
- 15. GRADED AREAS AROUND THE PROJECT PERIMETER MUST DRAIN AWAY FROM THE FACE OF THE SLOPE AT THE CONCLUSION OF EACH WORKING

LEGEND

BEST MANAGEMENT PROTECTION

DESCRIPTION	SYMBOL
WM-1 MATERIAL DELIVERY STORAGE	
WM-5 SOLID WASTE MANAGEMENT	
WM-6 HAZARDOUS WASTE MANAGEMENT	\triangle
WM-8 CONCRETE WASTE MANAGEMENT	COM
WM-9 SANITARY/SEPTIC WASTE MANAGEMENT	N
SC-8-GRAVEL BAG BARRIER	
FIBER ROLL	

IN THE IMMINENT EVENT OF PRECIPITATION ALL EXPOSED DRIVEWAYS. OR CROSS GUTTERS. SHALL BE PROTECTED WITH (A MINIMUM 20-FOOT LENGTH) OF 1" ROCK/GRAVEL DURING CONSTRUCTION

LOCATION OF BEST MANAGEMENT PROTECTION, INDICATED BY WM-1 THROUGH WM-9. ARE NOT SHOWN ON THIS PLAN. CONTRACTOR MAY MAKE ARRANGEMENTS TO UTILIZE SITES, AS INDICATED IN SPECIFICATION, ALONG INDIVIDUAL LOCATIONS. CONTRACTOR'S Q.S.P. SHALL DETERMINE APPROPRIATE LOCATIONS, DOCUMENT LOCATIONS IN SWPPP AND OBTAIN APPROVAL FROM ENGINEER AND THE INSPECTOR IN THE FIELD

1. CONTRACTOR TO PLACE INLET PROTECTION PER INLET PROTECTION DETAIL (EITHER OPTION 1 OR OPTION 2) LOCATED ON THIS SHEET. WHEN NEEDED AT COMMENCEMENT OF WORK AT EACH INDIVIDUAL LOCATION, ON STREETS INDICATED TO HAVE A GRIND AND OVERLAY. ALL OTHER REQUIRED EROSION CONTROL MEASURES SHALL BE INSTALLED AT THE APPROPRIATE TIME AS DICTATED BY THE CONSTRUCTION SEQUENCE AND THE CITY INSPECTOR.

2. GRAVEL BAG CHECK DAMS TO BE PLACED WITHIN STREET AREAS PER EROSION CONTROL NOTES LOCATED ON THIS SHEET AND PER DETAIL SHOWN ON THESE PLANS.

3. EROSION CONTROL BMPs SHALL BE INSTALLED AT LOCATIONS AS DESCRIBED IN THE NOTES AND DETAILS AND AT LOCATIONS DETERMINED BY THE INSPECTOR DURING CONSTRUCTION, BASED ON CURRENT FIELD CONDITIONS. CONTRACTOR WILL COORDINATE WITH CITY INSPECTOR TO CLEARLY DEMONSTRATE THE FUNCTIONAL ADEQUACY OF THE EROSION

CONTROL FACILITIES.		
	V.W.D. AS-BUILT	
	By:	10
SAN MARCOS FIRE DEPARTMENT	VALLECITOS WATER DISTRICT	
By: JASON NAILON, FIRE MARSHAL	By:	By:

INTERNATIONAL MBAKERINTL.COM

No. Description

INSPECTED AND RECOMMENDED 5050 Avenida Encinas FOR ACCEPTANCE Carlsbad, CA 92008 Phone: (760) 476-9193 Public Works Inspector CITY APPROVED CHANGES RECOMMENDED FOR APPROVAL App'd By Date

Date: 6/28/21

CURB, GUTTER AND SIDEWALK REPLACEMENT

-FLOW-

6'-0" MIN.

SPILLWAY-

REMAINING BERM

NOTES:

PROTECTION.

STACK GRAVEL-FILLED BAGS

AND 2-LAYERS HIGH FOR

1-LAYER HIGH FOR SPILLWAY

2. DIMENSIONS MAY VARY TO FIT FIELD CONDITIONS. 3. INSTALL A MINIMUM OF 3 GRAVEL BAG BERMS UPSTREAM OF EACH DRAINAGE INLET TO BE

1. PLACE SAFETY CONES ADJACENT TO DRAINAGE INLET

PERSPECTIVE VIEW GRAVEL BAG BARRIER

NOT TO SCALE

END OF GRAVEL BAG BERM -

EXTEND AS NECESSARY TO FORCE

INSTEAD OF OUT FLANKING AROUND

PONDED RUNOFF OVER SPILLWAY-

END OF BERM.

PROTECTED. 4. EROSION CONTROL BLANKET OR GEOSYNTHETIC FABRIC IS NOT REQUIRED IF THE AREA ADJACENT TO THE DRAINAGE INLET IS VEGETATED OR PAVED. **PLAN CODE** EC-1

VWD W.O. 207141

CONSTRUCT GRAVEL BAG BERM

-BY TIGHTLY ABUTTING GRAVEL-FILLED

BAGS TO ELIMINATE GAPS AND VOIDS

CITY OF SAN MARCOS ENGINEERING DIVISION City Drawing No. Description: CITY OF SAN MARCOS GPS PT. NO. 1017 AND EROSION & SEDIMENT CONTROL PLAN FOR:
GPS PT. NO. 1021 PER ROS 13928 SAN MARCOS BOULEVARD AT DISCOVERY IP18-00009 STREET INTERSECTION Sheet 18 of 29

PLACE GRAVEL BAGS ALONG NEW CURB FACE-WHEN ROUGH GRADED. 15 + 00SAN MARCOS BLVD PLAN INLET PROTECT TO NEXT NEAREST PLACE GRAVEL BAGS DOWN STREAM INLET ON BOTH SIDES OF ALONG NEW CURB FACE -SAN MARCOS BLVD. WHEN ROUGH GRADED. **CONSTRUCTION NOTES** (1) GRAVEL BAG CHECK DAM PER DETAIL 3 ON THIS SHEET GRAVEL-FILLED BAG (PLACE ONE BAG AT EACH END) (2) LIMITS OF WORK SECURE FILTER FABRIC (3) INLET PROTECTION PER DETAIL 2 ON THIS SHEET WITH GRAVEL BAGS (4) PERIMETER PROTECTION, FIBER ROLL OR EQUIVALENTS, SCALE: 1"=40' -EXISTING CURB INLET PER DETAIL 1 ON THIS SHEET "AS - BUILT" DECLARATION NOTES: AS ENGINEER-OF-WORK, I HEREBY CERTIFY THAT, TO THE BEST OF 1. INTENDED FOR SHORT-TERM USE. MY KNOWLEDGE AND BELIEF, THE IMPROVEMENTS SHOWN ON THIS SET 2. PLACE GRAVEL BAGS WITHIN GUTTER OUTSIDE OF A.C. PAVEMENT AND ON TOP OF CURB OF CONSTRUCTION PLANS, SHEET 18 TO 19, HAVE BEEN INSTALLED 3. USE TO INHIBIT STORM WATER AND NON-STORM DEBRIS. AND CONSTRUCTED IN SUBSTANTIAL CONFORMANCE WITH THESE 4. CLEAN AFTER EVERY STORM EVENT. AS-BUILT PLANS, INCLUDING ALL APPROPRIATE STANDARDS AND 5. REMOVE DEBRIS DAM AFTER ALL CONSTRUCTION OPERATIONS ARE COMPLETE. ANY DISCRETIONARY APPROVAL(S) FOR THE PROJECT. 6. DAILY INSPECTION SHALL BE MADE BY THE CONTRACTOR'S Q.S.P.. SILT & DEBRIS ACCUMULATION MUST BE REMOVED AS IT ACCUMULATES. PLAN INLET PROTECT TO NEXT NEAREST 7. CONTRACTOR SHALL MONITOR THE PERFORMANCE OF INLET PROTECTION DOWN STREAM INLET ON BOTH SIDES OF PRINTED NAME DURING EACH RAINFALL EVENT AND GRINDING OPERATIONS. DISCOVERY ST. DISCIPLINE_ _MY REGISTRATION EXPIRES — PLACE ADDITIONAL BAGS ON TOP OF **INLET PROTECTION DETAIL** -CURB AND UPSTREAM OF GRAVEL BAG BERM TO PREVENT OVER TOPPING. NOT TO SCALE INSTALL GRAVEL-FILLED BAGS FLUSH AGAINST CURB OR DIKE FACE.

SEE NOTE 12 OF

CONTROL NOTES


STORMWATER & EROSION

PLAN VIEW FOR FLOW-BY CONDITION

NOT TO SCALE

4'-0" MIN. FROM EDGE

OF TRAVELED WAY

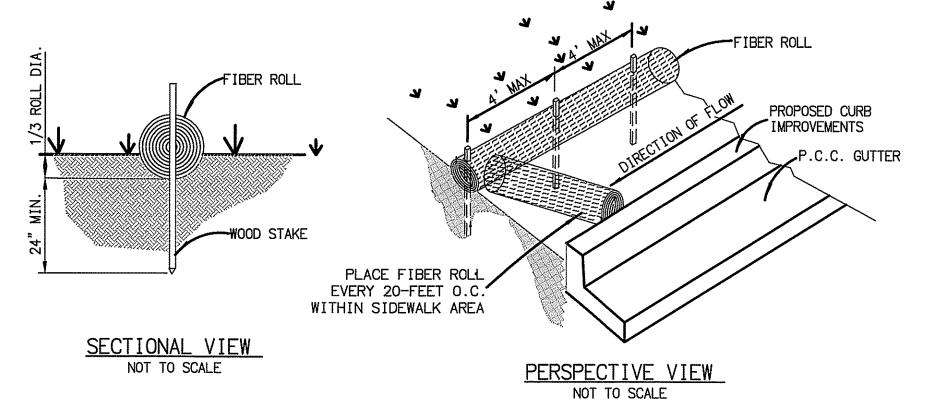

FIBER ROLL PLACEMENT NOT TO SCALE

GRAVEL BAG PROTECTION FOR

BENCH MARK

Location: PT. NO. 1017: N1992455.016 E6270654.355 PT. NO. 1021: N1992450.992 E6274932.043 Elev.: 513.042 [510.736] Datum: NAVD 1988 [NGVD VWD 29]

ENGINEER OF WORK

Name: JOSH C. STONE Date: 3-29.2/ R.C.F.: C60755

__exp:_12/31/22


By: Lewis Clapp, Senior Civil Engineer Isaac Etchamendy, City Engineer . exp.: 12/31/2022 R.C.E. 81294 exp.: 09/30/202/

FACE OF CURB


DRAINAGE INLET-

APPROVED FOR CONSTRUCTION


Date: RCE C60160 EXP 6/30/2022 H: \PDATA\163212_DISCOVERY ST\CADD\LAND\DLV\IMPROVE\163212-18-EC-55T.DWG LIU, LEO 3/10/2021 9:33 AM

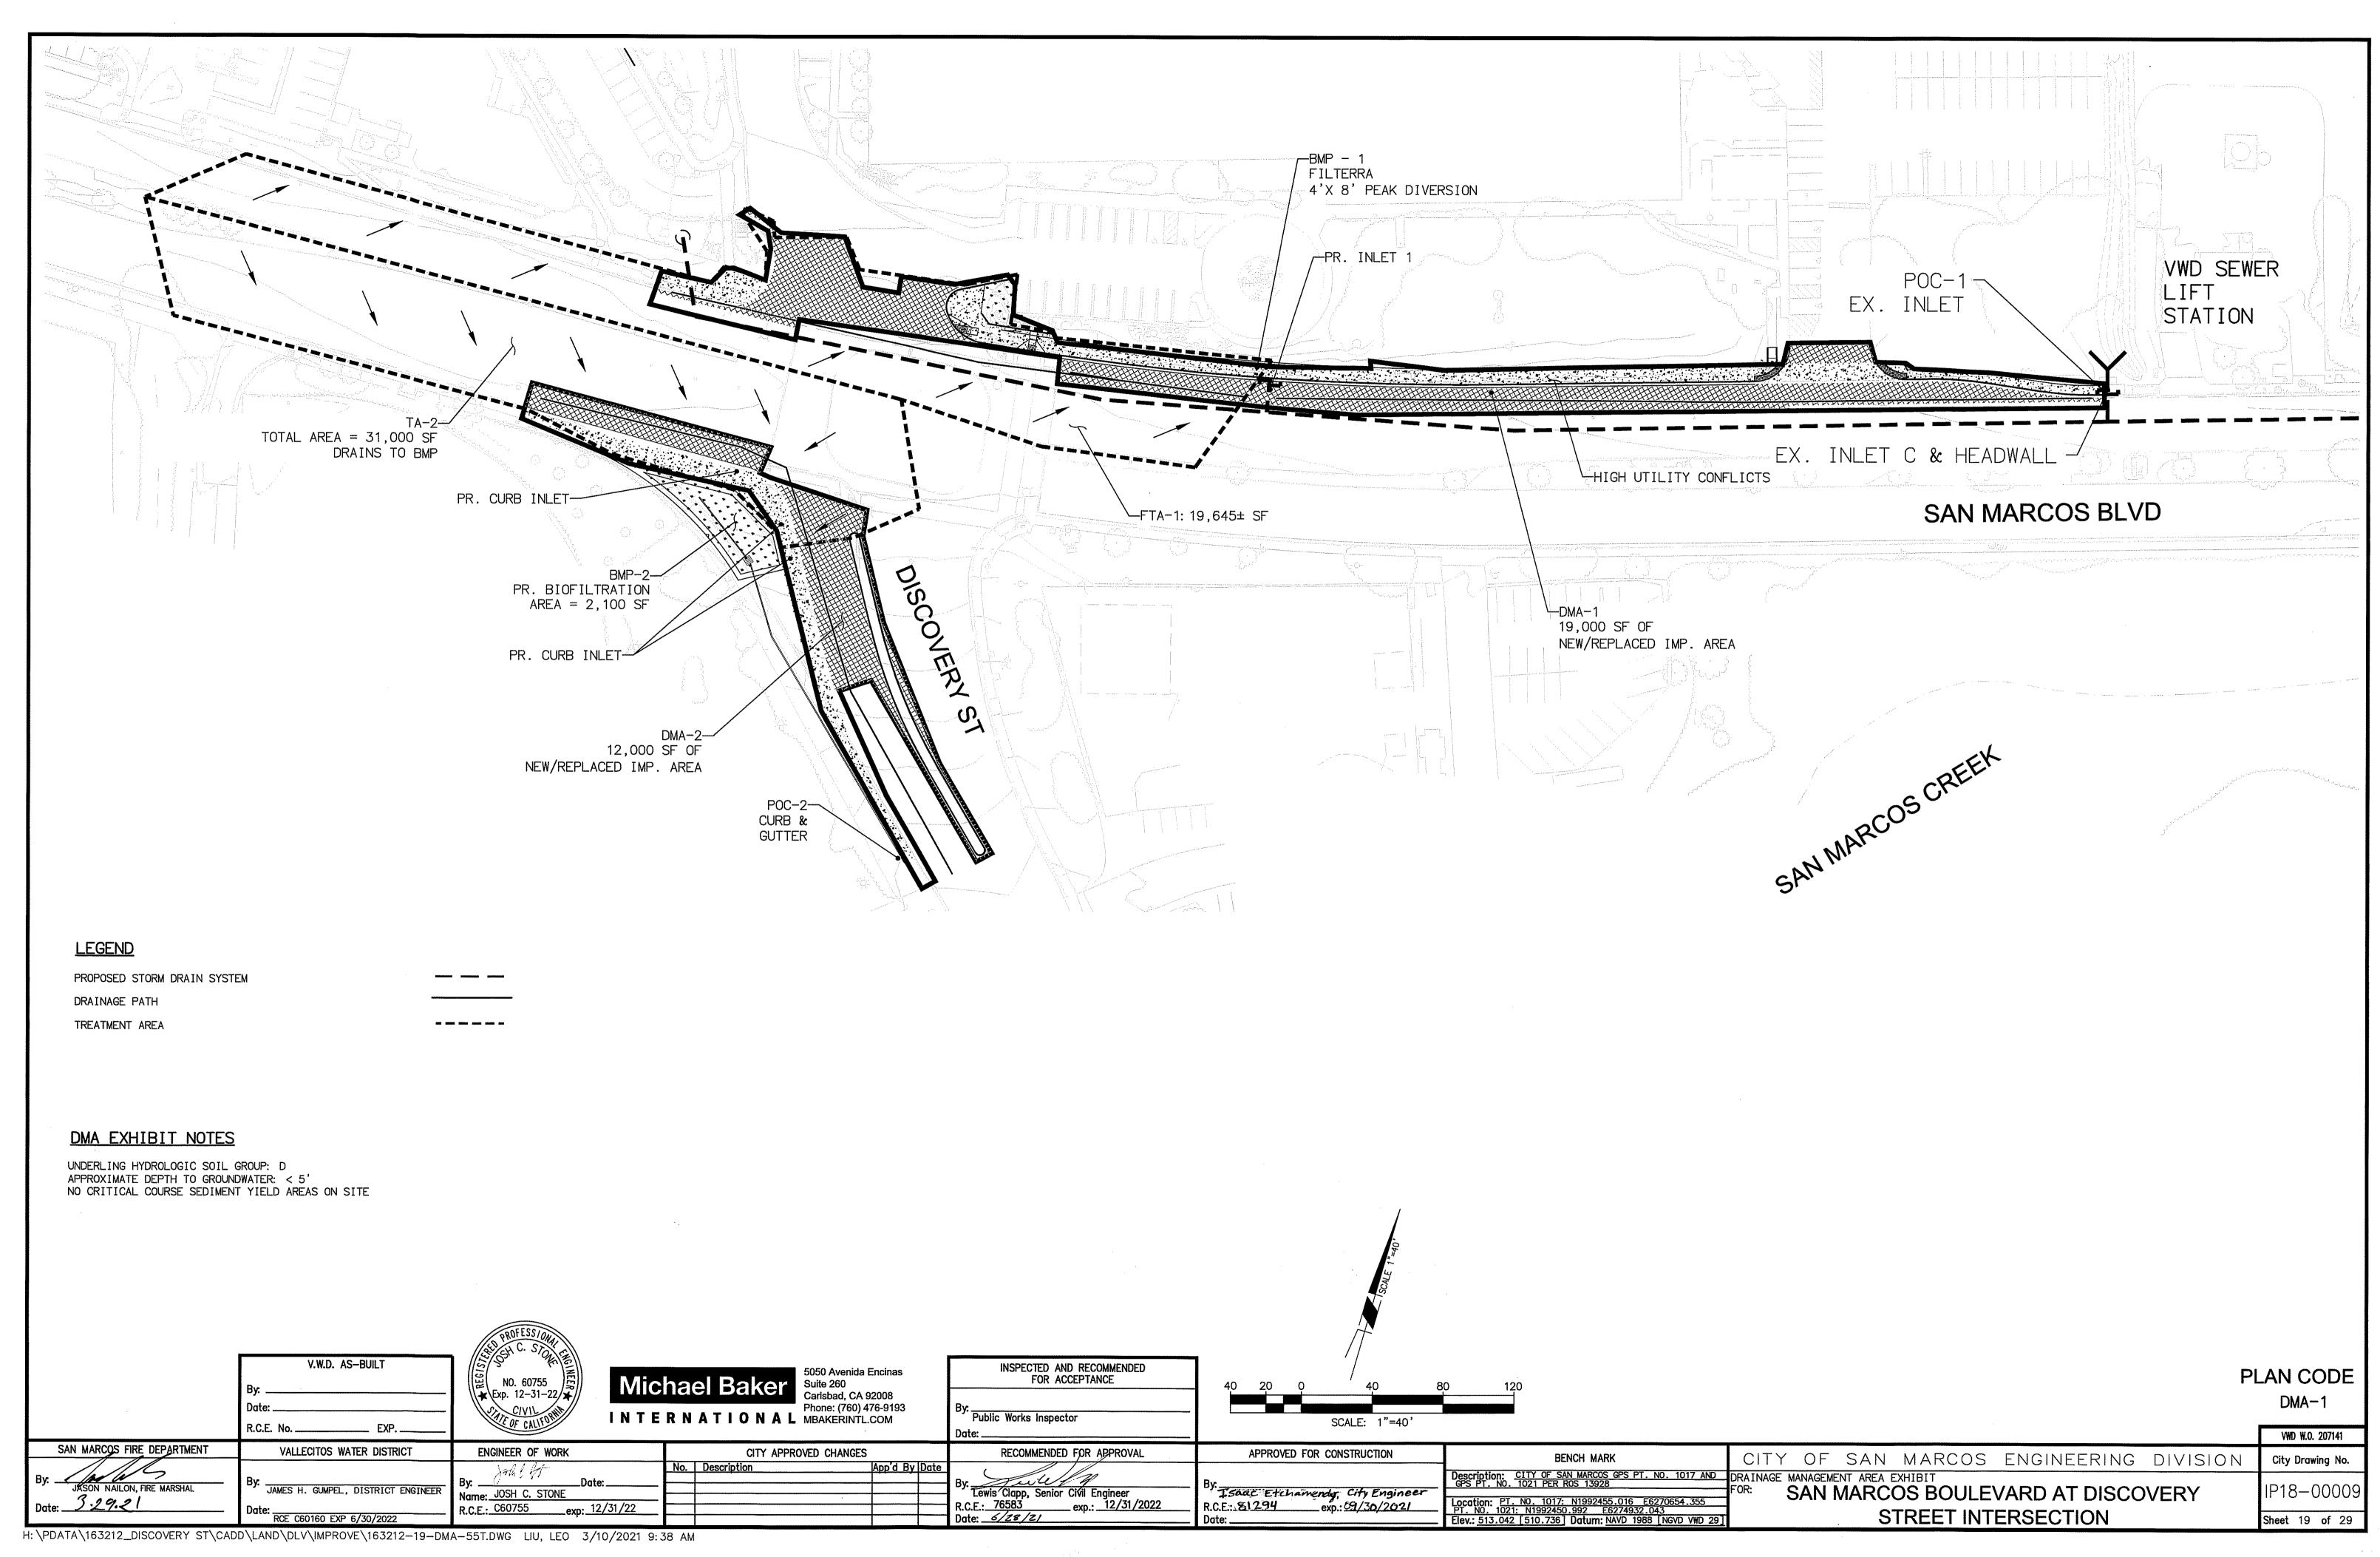



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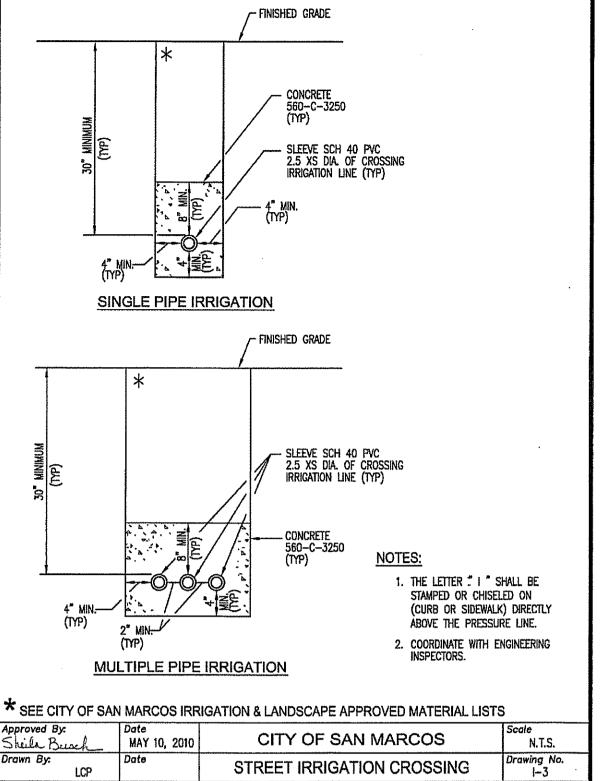
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I AGREE TO COMPLY WITH THE REQUIREMENTS OF THE WATER EFFICIENT LANDSCAPE REGULATIONS AND SUBMIT A COMPLETE LANDSCAPE DOCUMENTATION PACKAGE.

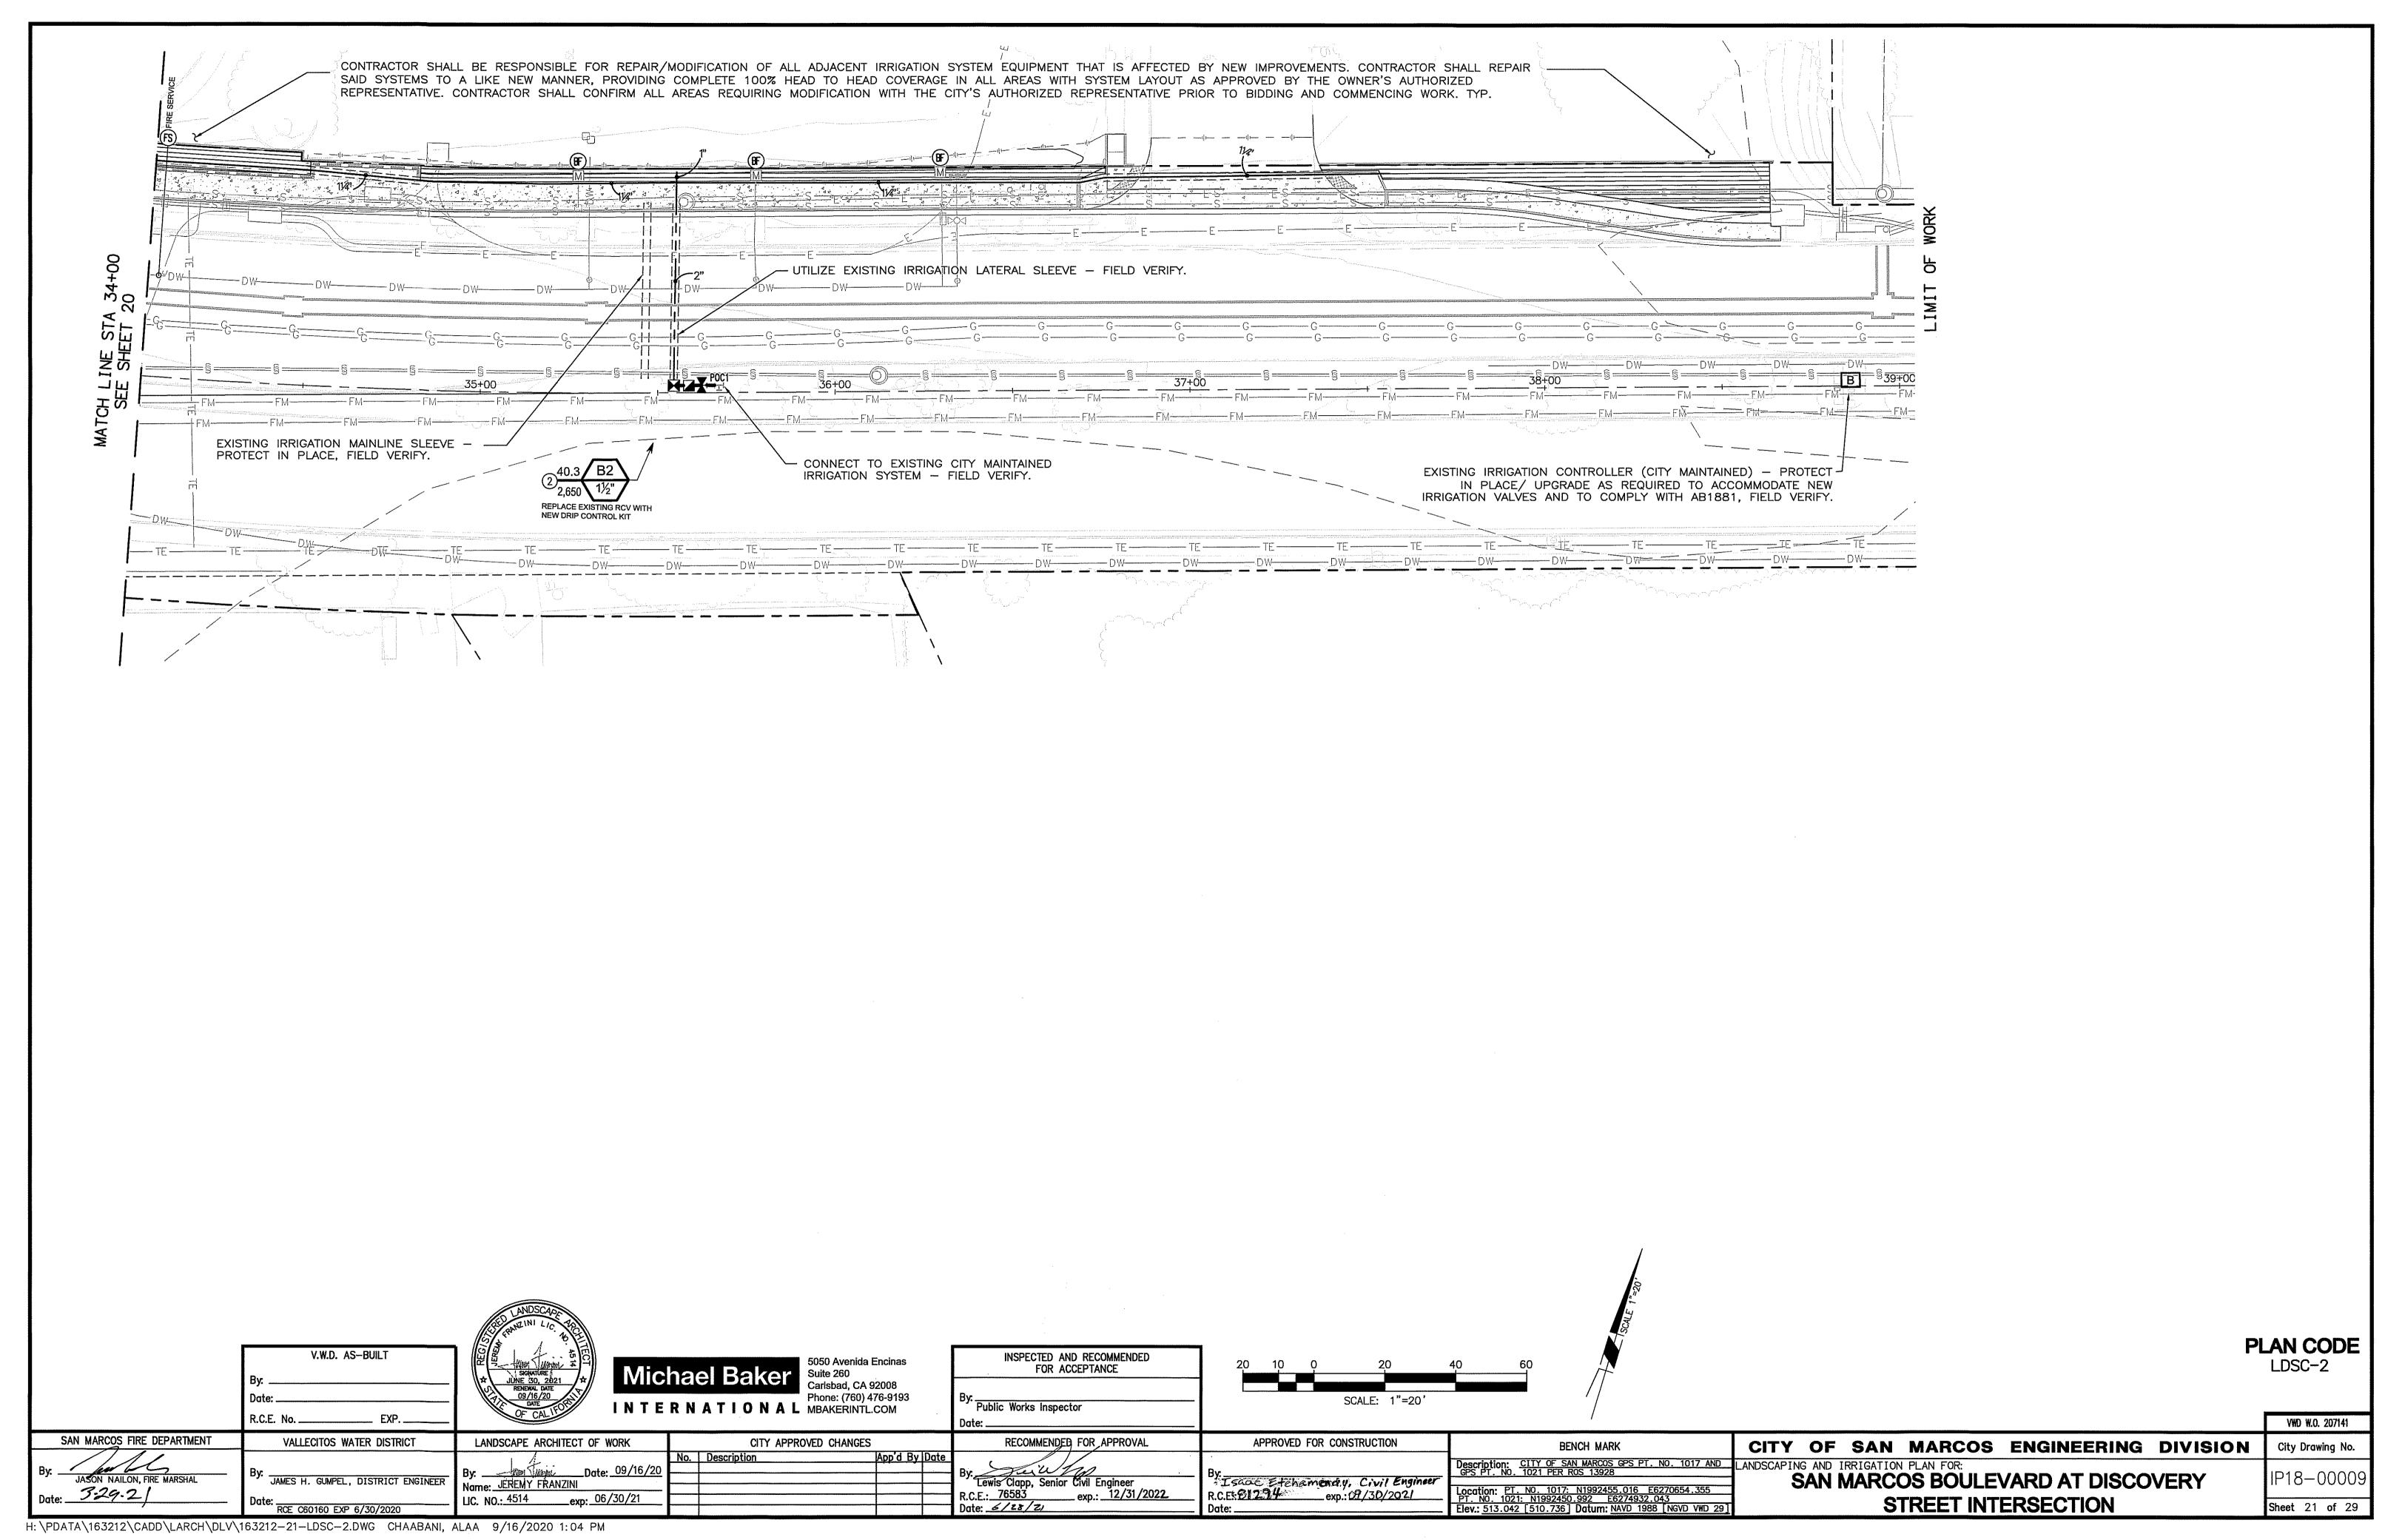

IRRIGATION NOTES:

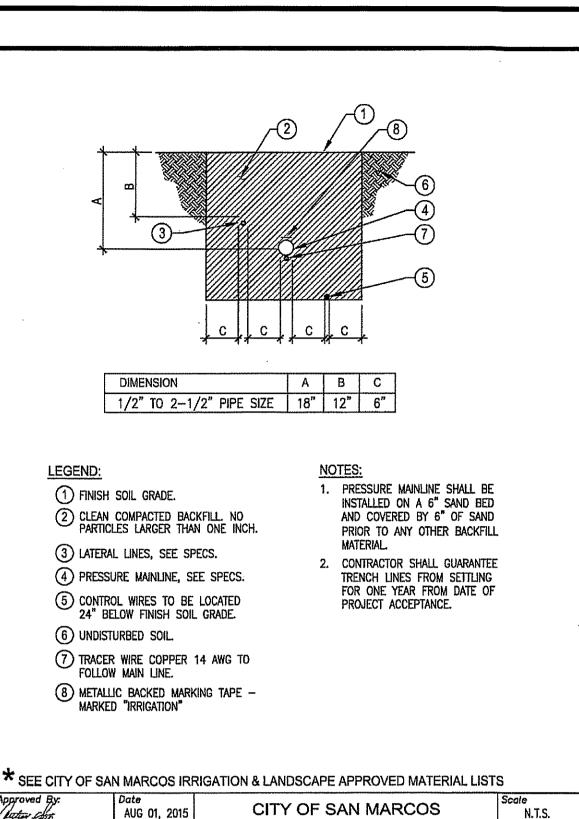- 1. ALL LANDSCAPE AND IRRIGATION WORK SHALL CONFORM TO CITY SAN MARCOS LANDSCAPE STANDARDS, THE LATEST EDITION OF THE STANDARD SPECIFICATIONS FOR PUBLIC WORKS CONSTRUCTION "GREEN BOOK" (A COPY SHALL BE KEPT ON THE JOB SITE AT ALL TIMES), THE SPECIFICATION SPECIAL PROVISIONS, LOCAL CODES AND ORDINANCES, AND ALL OTHER LANDSCAPE RELATED CITY AND REGIONAL STANDARDS. ALL WORK SHALL BE SUBJECT TO THE CITY ENGINEER'S ACCEPTANCE AS A CONDITION OF COMPLETION OF WORK BY THE CONTRACTOR.
- 2. CONTRACTOR SHALL BE RESPONSIBLE FOR COORDINATION OF ACTIVITIES WITH ALL AGENCIES AND OTHER TRADES.
- 3. THE CONTRACTOR SHALL OBTAIN, COORDINATE AND PAY FOR ANY AND ALL PERMITS AND ALL INSPECTIONS AS REQUIRED.
- 4. THE CONTRACTOR SHALL BE RESPONSIBLE AND LIABLE FOR ANY ENCROACHMENT INTO ADJACENT PROPERTY, R.O.W.'S, EASEMENTS, SETBACKS OR ANY OTHER LEGAL PROPERTY RESTRICTIONS EITHER MARKED OR UNMARKED.
- 5. IT SHALL BE THE RESPONSIBILITY OF THE CONTRACTOR TO FAMILIARIZE HIMSELF WITH ALL UNDERGROUND UTILITIES. CONTRACTOR SHALL REPAIR/REPLACE, AT NOT ADDITIONAL COST TO THE OWNER, ANY DAMAGE TO UNDERGROUND UTILITIES THAT MAY OCCUR.
- 6. THE CONTRACTOR SHALL VERIFY ALL CONDITIONS AND DIMENSIONS SHOWN ON PLANS AT THE SITE PRIOR TO COMMENCEMENT OF ANY WORK. ALL DISCREPANCIES SHALL BE IMMEDIATELY REPORTED TO PROJECT LANDSCAPE ARCHITECT AND THE CITY ENGINEER FOR DIRECTION. ANY CONTINUATION OF WORK IS AT THE CONTRACTOR RISK AND EXPENSE.
- 7. THE CONTRACTOR SHALL ONLY APPLY SUFFICIENT WATER TO PROMOTE HEALTHY GROWTH OF THE PLANT MATERIAL. AT NO TIME WILL THE CONTRACTOR APPLY WATER AT A RATE OF FREQUENCY WHICH CAUSES RUN-OFF OR SOIL SATURATION.
- 8. THE WORK ON THESE PLANS IS DIAGRAMMATIC. ALL ITEMS, I.E. CONTROLLERS, VALVES, MAINLINES, SLEEVES, WIRES, IRRIGATION HEADS ETC. ARE SHOWN IN THEIR APPROXIMATE LOCATIONS ONLY AND SHALL BE INSTALLED IN PLANTING AREAS, TYPICAL. DO NOT SCALE DIMENSIONS. DETAIL DRAWINGS MAY CLARIFY LOCATION OF SOME ITEMS. THE CONTRACTOR SHALL NOT LOCATE ANY ITEMS WHERE IT IS OBVIOUS THAT THEY ARE IN CONFLICT WITH UNDERGROUND UTILITIES, STRUCTURES, OTHER IMPROVEMENTS, OR VEHICULAR OR PEDESTRIAN SAFETY CONSIDERATIONS.
- 9. SLEEVE IRRIGATION WIRING UNDER ALL PAVING. SLEEVE IRRIGATION LATERALS UNDER ALL PAVING. SLEEVE MAINLINE UNDER ALL PAVING. ALL SLEEVES TO 2x SIZE OF PIPE TO BE SLEEVED.
- 10. USE CHECK VALVES AS REQUIRED TO ELIMINATE LOW HEAD DRAINAGE.

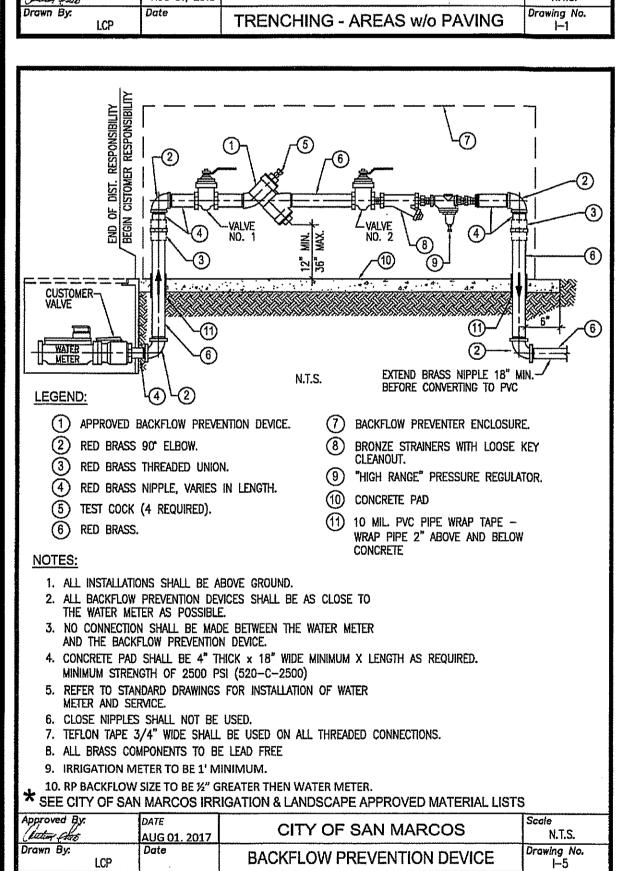ROADS OR MAINTENANCE PADS.

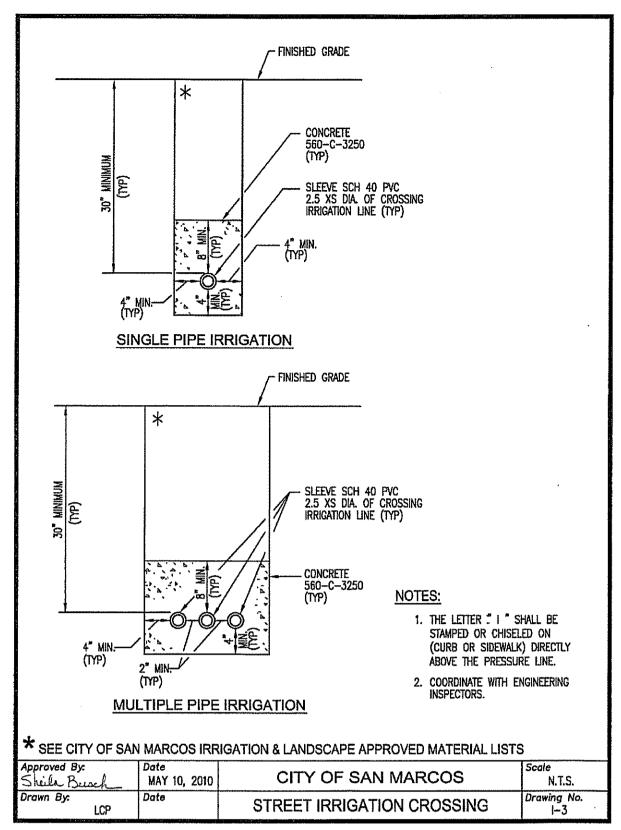- 11. THE CONTRACTOR SHALL FLUSH AND ADJUST ALL SPRINKLER HEADS FOR OPTIMUM PERFORMANCE AND TO PREVENT OVERSPRAY ONTO WALKS, ROADWAYS AND/OR BUILDINGS AS MUCH AS POSSIBLE. THIS SHALL INCLUDE ADJUSTING THE HEADS, SELECTING THE BEST DEGREE OF ARC TO FIT THE EXISTING SITE CONDITIONS AND TO THROTTLE THE FLOW CONTROL AT EACH VALVE TO OBTAIN THE OPTIMUM OPERATING PRESSURE FOR EACH SYSTEM.
- 12. ALL HEADS ARE TO BE INSTALLED WITH THE NOZZLE, SCREEN AND ARCS SHOWN ON THE PLANS. ALL HEADS ARE TO BE ADJUSTED TO PREVENT OVERSPRAY ONTO BUILDINGS, WALLS, PICNIC TABLE, BENCH, BBQ GRILL, DRINKING FOUNTAINS, FENCES AND HARDSCAPE. THIS INCLUDES, BUT NOT LIMITED TO, ADJUSTMENT OF DIFFUSER PIN OR ADJUSTMENT SCREW, REPLACEMENT OF PRESSURE COMPENSATING SCREENS, REPLACEMENT OF NOZZLES WITH MORE APPROPRIATE RADIUS UNITS AND THE REPLACEMENT OF NOZZLES WITH ADJUSTABLE ARC UNITS.
- 13. WHEN VERTICAL OBSTRUCTIONS (STREET LIGHTS, TREES, ETC.) INTERFERE WITH THE SPRAY PATTERN OF THE SPRINKLER HEADS SO AS TO PREVENT PROPER COVERAGE, THE IRRIGATION CONTRACTOR SHALL FIELD ADJUST THE SPRINKLER SYSTEM BY INSTALLING A QUARTER CIRCLE OR HALF CIRCLE SPRINKLER HEAD ON EACH SIDE OF THE OBSTRUCTION SO AS TO PROVIDE PROPER COVERAGE. ALL ADJUSTMENTS SHALL BE MADE AT NO ADDITIONAL COST TO THE OWNER.
- 14. IRRIGATION SYSTEMS SHALL NOT SPRAY DIRECTLY ONTO ANY GAS OR ELECTRIC FACILITIES, ACCESS
- 15. A CERTIFICATE OF COMPLETION SHALL BE FILLED OUT AND CERTIFIED BY EITHER THE DESIGNER OR THE LANDSCAPE PLANS, IRRIGATION PLANS, OR LICENSED LANDSCAPE CONTRACTOR FOR THE
- 16. AN IRRIGATION AUDIT REPORT SHALL BE COMPLETED AT THE TIME OF FINAL INSPECTION. CONTRACTOR WILL BE REQUIRED TO HIRE A THIRD PARTY CERTIFIED LANDSCAPE IRRIGATION AUDITOR TO PROVIDE AN AUDIT REPORT TO THE CITY ON THE NEW AND MODIFIED PORTIONS OF THE IRRIGATION SYSTEM IN CONFORMANCE WITH AB 1881 REQUIREMENTS. CONTRACTOR WILL ALSO BE RESPONSIBLE TO MAKE ANY RECOMMENDED REPAIR OR CORRECTIONS THAT RESULT FROM THE IRRIGATION AUDIT REPORT AT NO COST TO THE CITY.
- 17. A DIAGRAM OF THE IRRIGATION PLAN SHOWING HYDROZONES SHALL BE KEPT WITH THE IRRIGATION CONTROLLER FOR SUBSEQUENT MANAGEMENT PURPOSES.
- 18. ALL IRRIGATION EQUIPMENT SHALL BE LOCATED IN THE CITY RIGHT-OF-WAY.
- 19. CONTRACTOR SHALL MEET WITH THE CITY MAINTENANCE REPRESENTATIVE AT THE PROJECT SITE TO LOCATE EXISTING IRRIGATION WATER METERS, BACKFLOW PREVENTERS, MASTER VALVES, FLOW SENSORS. REMOTE CONTROL VALVES, MAINLINE, CONTROLLERS AND ALL OTHER PERTINENT SITE
- 20. PRIOR TO DEMOLITION AND INSTALLATION OF NEW IMPROVEMENTS, CONTRACTOR SHALL IDENTIFY ITEMS TO BE REMOVED AND/OR RELOCATED. CONTRACTOR IS RESPONSIBLE FOR MAINTAINING IRRIGATION WATER TO EXISTING LANDSCAPE AREAS ADJOINING THE LIMIT OF WORK AND AREAS AFFECTED BY THE NEW IMPROVEMENTS. THE CONTRACTOR SHALL BARE ALL COSTS ASSOCIATED WITH LACK OF IRRIGATION WATER.
- 21. CONTRACTOR SHALL BE PRESENT DURING GRADING OPERATIONS TO PERFORM NECESSARY SERVICES AND PROVIDE ALL EQUIPMENT NECESSARY FOR CAPPING THE EXISTING SYSTEM AND MAKING NECESSARY ADJUSTMENTS TO EXISTING SYSTEMS TO ENSURE SYSTEMS REMAIN OPERATIONAL TO THOSE AREAS LOCATED OUTSIDE THE LIMIT OF WORK DEPICTED ON THESE PLANS.
- 22. CONTRACTOR SHALL BE RESPONSIBLE FOR THE INSTALLATION OF ALL MATERIAL APPEARING ON
- 23. CONTRACTOR SHALL PROVIDE ALL MATERIALS, LABOR AND EQUIPMENT NECESSARY TO ENSURE FULLY OPERATION IRRIGATION SYSTEMS AS DETERMINED BY CITY ENGINEER.
- 24. SEE THE SPECIFICATION SPECIAL PROVISIONS FOR ADDITIONAL REQUIREMENTS.

IRRIGATION SCHEDULE

MANUFACTURER/MODEL/DESCRIPTION

RAIN BIRD XCZ-100-PRB-COM WIDE FLOW DRIP CONTROL KIT FOR COMMERCIAL APPLICATIONS. 1" BALL VALVE WITH 1" PESB VALVE AND 1" PRESSURE REGULATING 40PSI QUICK-CHECK BASKET FILTER. 0.3 GPM TO 20 GPM. (CONNECT TO PRIVATELY MAINTAINED SYSTEM, UTILIZE EXISTING CONTROL WIRE)

RAIN BIRD XCZ-150-LCDR

HIGH FLOW CONTROL ZONE KIT, FOR LARGE COMMERCIAL DRIP ZONES. 1-1/2" PESB-R SCRUBBER GLOBE VALVE WITH SINGLE 1-1/2" PRESSURE REGULATING (40PSI) QUICK-CHECK BASKET FILTERS. FLOW RANGE: 15-62 GPM. (CONNECT TO CITY MAINTAINED SYSTEM, UTILIZE EXISTING CONTROL WIRE)

NETAFIM 65ARIA075 NOT SHOWN 3/4" MALE PIPE THREAD GUARDIAN AIR/VACUUM RELIEF VENT. INSTALL ONE PER STATION PER MANUFACTURER AT THE HIGHEST POINT IN SUBSURFACE SYSTEMS.

NOT SHOWN RAIN BIRD MDCFCAP

DRIPLINE FLUSH VALVE CAP IN COMPRESSION FITTING COUPLER. INSTALL PER MANUFACTURER AT END OF

NOT SHOWN HUNTER ECO-ID

<u>SYMBOL</u>

ECO-ID: 1/2" FPT CONNECTION WITH 12-60 PSI OPERATING PRESSURE. INSTALL ONE PER STATION PER MANUFACTURER WITH HUNTER SJ SWING JOINT.

AREA TO RECEIVE DRIPLINE (PRIVATELY MAINTAINED SYSTEM) RAIN BIRD XFS-09-12

XFS SUB-SURFACE PRESSURE COMPENSATING DRIPLINE W/COPPER SHIELD TECHNOLOGY, 0.9 GPH EMITTERS AT 12" O.C. LATERALS SPACED AT 12" APART, WITH EMITTERS OFFSET FOR TRIANGULAR PATTERN. UV RESISTANT. SPECIFY XF INSERT FITTINGS. INSTALL WITH DRIP RINGS FOR EACH TREE PER MANUFACTURER.

AREA TO RECEIVE DRIPLINE (CITY MAINTAINED SYSTEM) RAIN BIRD XFS-CV-09-12

XFS-CV SUB-SURFACE LANDSCAPE DRIPLINE WITH A HEAVY-DUTY 4.3 PSI CHECK VALVE. 0.9 GPH EMITTERS AT 12" O.C. DRIPLINE LATERALS SPACED AT 12" APART, WITH EMITTERS OFFSET FOR TRIANGULAR PATTERN. SPECIFY XF INSERT FITTINGS. INSTALL WITH DRIP RINGS FOR EACH TREE PER MANUFACTURER.

AREA TO RECEIVE DRIPLINE (CITY MAINTAINED SYSTEM) RAIN BIRD XFS-CV-06-18

XFS-CV ON-SURFACE LANDSCAPE DRIPLINE WITH A HEAVY-DUTY 4.3 PSI CHECK VALVE. 0.6 GPH EMITTERS AT 18" O.C. DRIPLINE LATERALS SPACED AT 18" APART, PARALLEL TO CONTOURS WITH EMITTERS OFFSET FOR TRIANGULAR PATTERN. SPECIFY XF INSERT FITTINGS. INSTALL WITH DRIP RINGS FOR EACH TREE

PER MANUFACTURER. MANUFACTURER/MODEL/DESCRIPTION

PROVIDE CARSON VALVE BOXES FOR ALL VALVES (TAN, MODELS 1419, 1220, 708, 910)

INLET, 2-PIECE BODY. ACME KEY WITH ANTI-ROTATION WINGS.

QUICK COUPLER VALVE, YELLOW RUBBER LOCKING COVER, RED BRASS AND STAINLESS STEEL, WITH 1" NPT

NIBCO T-580-S6-R-66-LL

STAINLESS STEEL BALL VALVE SHUT OFF VALVE EXISTING IRRIGATION CONTROLLER (CITY MAINTAINED SYSTEM) - PROTECT IN PLACE, FIELD VERIFY.

DOMESTIC WATER POINT OF CONNECTION (CITY MAINTAINED SYSTEM): APPROXIMATE LOCATION OF EXISTING IRRIGATION MAINLINE - FIELD VERIFY PRESSURE, SIZE AND LOCATION.

(EXISTING MAINLINE CONNECTED TO EXISTING 2" DOMESTIC WATER METER "B" PER AS-BUILT PLANS DATED 11-3-09). SEE CIVIL PLANS FOR METERS RELOCATION. CONTRACTOR TO RECERTIFY ALL RELOCATED BACKFLOW PREVENTERS PER VWD REQUIREMENTS.

DOMESTIC WATER POINT OF CONNECTION (PRIVATELY MAINTAINED SYSTEM) APPROXIMATE LOCATION OF EXISTING IRRIGATION MAINLINE - FIELD VERIFY PRESSURE, SIZE AND LOCATION. (EXISTING MAINLINE CONNECTED TO EXISTING 2" DOMESTIC WATER METER "C" PER AS-BUILT PLANS DATED 11-3-09). SEE CIVIL PLANS FOR METERS RELOCATION. CONTRACTOR TO RECERTIFY ALL RELOCATED

BACKFLOW PREVENTERS PER VWD REQUIREMENTS. - IRRIGATION LATERAL LINE: PVC SCHEDULE 40

IRRIGATION MAINLINE: PVC SCHEDULE 40

INSTALL WITH ALL PIPE/WIRE UNDER PAVEMENT, EITHER SHOWN OR NOT SHOWN ON THE PLANS. ALL SLEEVES TO BE MIN. 2x PIPE DIAMETER OF THE PIPE/ WIRE BUNDLE SLEEVED. COORDINATE INSTALLATION OF SLEEVE

THROUGH WALLS WITH CIVIL PLANS, THE GENERAL CONTRACTOR AND ALL OTHER RELATED TRADES. _____EXISTING IRRIGATION SLEEVE - PROTECT IN PLACE/ UTILIZE AS REQUIRED FOR NEW CONTROL WIRE.

PIPE SIZE LEGEND

-/-/-/- EXISTING IRRIGATION LATERAL - DISCONNECT/ ABANDON IN PLACE, FIELD VERIFY

---- VALVE NUMBER #)- HYDROZONE NUMBER #"1 # LANDSCAPE AREA (SF) ---- VALVE SIZE

HYDROZONE LEGEND

(1) LOW WATER USE PLANT W/ DRIP IRRIGATION (2) MEDIUM WATER USE PLANT W/ DRIP IRRIGATION

GPM 3/4" MIN. 8-12 GPM 13-21 GPM 1-1/4" 22-31 GPM 1-1/2" 32-50 GPM 51-70 GPM 2-1/2" 71-100 GPM 3" 1/2" PIPE IS NOT ALLOWED. MINIMUM SIZE PIPE TO BE 3/4". CONTRACTOR

TO SIZE PIPE BASED ON CHART ABOVE.

PLAN CODE LDSC-3

	V.W.D. AS-BUILT By: Date: R.C.E. No EXP	JEREN JUNE 30, 2021 RENEWAL DATE 09/16/20 DATE OF CALLFORD N
SAN MARCOS FIRE DEPARTMENT	VALLECITOS WATER DISTRICT	LANDSCAPE ARCHITECT OF WORK

JASON NAILON, FIRE MARSHAL

Date: 3-29-2



_Date: 09/16/2u

__exp: 06/30/21

No. Description

ANDSCA

Name: JEREMY FRANZINI

LIC. NO.: 4514

2-13-2020 5050 Avenida Encinas Carlsbad, CA 92008 Phone: (760) 476-9193

FOR ACCEPTANCE By: Public W Date: ___ CITY APPROVED CHANGES <u>|App'd By|Date</u> Lewis 6

R.C.E.: 765

کے :Date

INSPECTED AND RECOMMENDED

Works Inspector		
RECOMMENDED FOR APPROVAL	APPROVED FOR CONSTRUCTION	BENCH MARK
Tui William	By:	Description: CITY OF SAN MARCOS GPS PT. NO. 1017 AND GPS PT. NO. 1021 PER ROS 13928
Clapp, Senior Civil Engineer 5583 exp.: 12/31/202 2	R.C.E.181294 exp.: 09/30/2021	Location: PT. No. 1017: N1992455.016 E6270654.355 PT. No. 1021: N1992450.992 E6274932.043
/28/2,	Date:	Elev.: 513.042 [510.736] Datum: NAVD 1988 [NGVD VWD 29]


CITY OF SAN MARCOS ENGINEERING DIVISION D. 1017 AND LANDSCAPING AND IRRIGATION PLAN FOR: SAN MARCOS BOULEVARD AT DISCOVERY STREET INTERSECTION

City Drawing No. IP18-00009 Sheet 22 of 29

VWD W.O. 207141

Date: RCE C60160 EXP 6/30/2020 H:\PDATA\163212\CADD\LARCH\DLV\163212-22-LDSC-3.DWG CHAABANI, ALAA 9/16/2020 1:28 PM

JAMES H. GUMPEL, DISTRICT ENGINEER

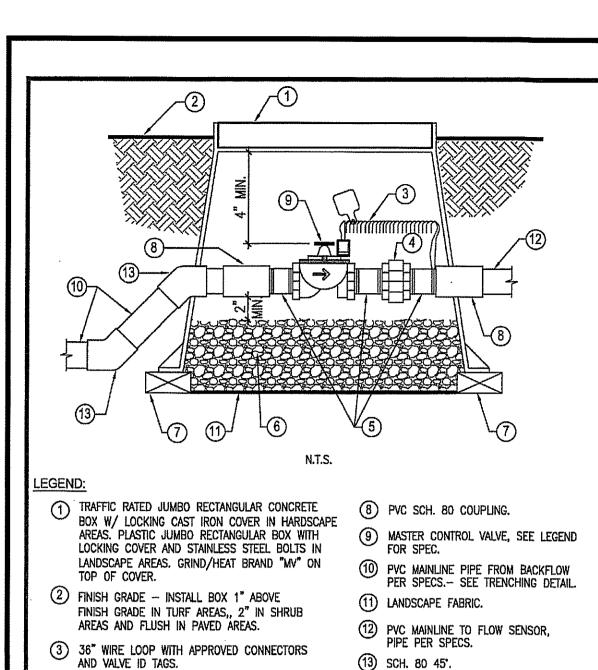

* SEE CITY OF SAN MARCOS IRRIGATION & LANDSCAPE APPROVED MATERIAL LISTS

CITY OF SAN MARCOS

MASTER CONTROL VALVE

N.T.S.

(4) BRASS UNION.

(5) BRASS NIPPLES

(6) 3/4" ROCK, 2 CUBIC FT.

7 BRICK SUPPORTS OR CONCRETE


BLOCKINGS, 4 MINIMUM.


SAN MARCOS_FIRE DEPARTMENT


JASON NAILON, FIRE MARSHAL


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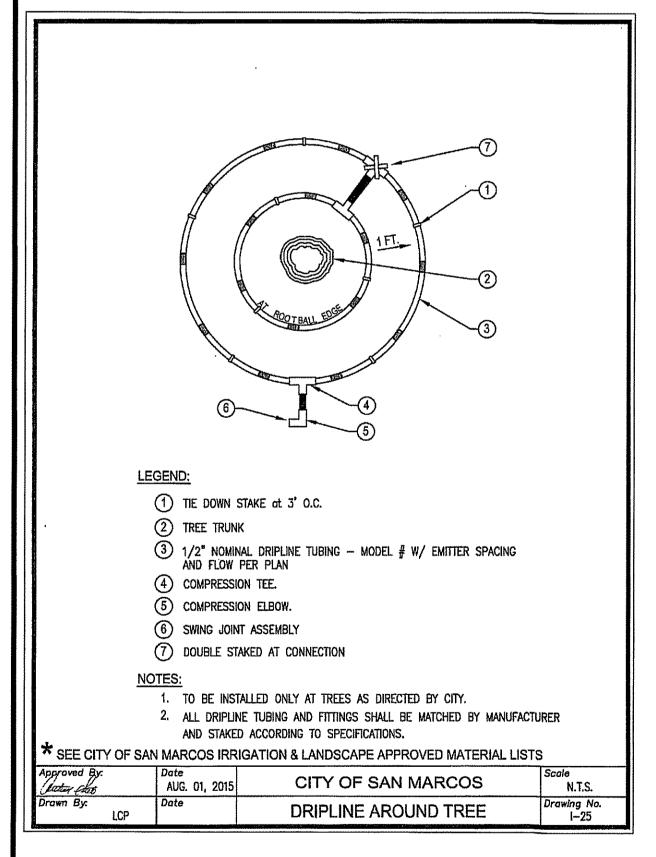
AUG. 01, 2015




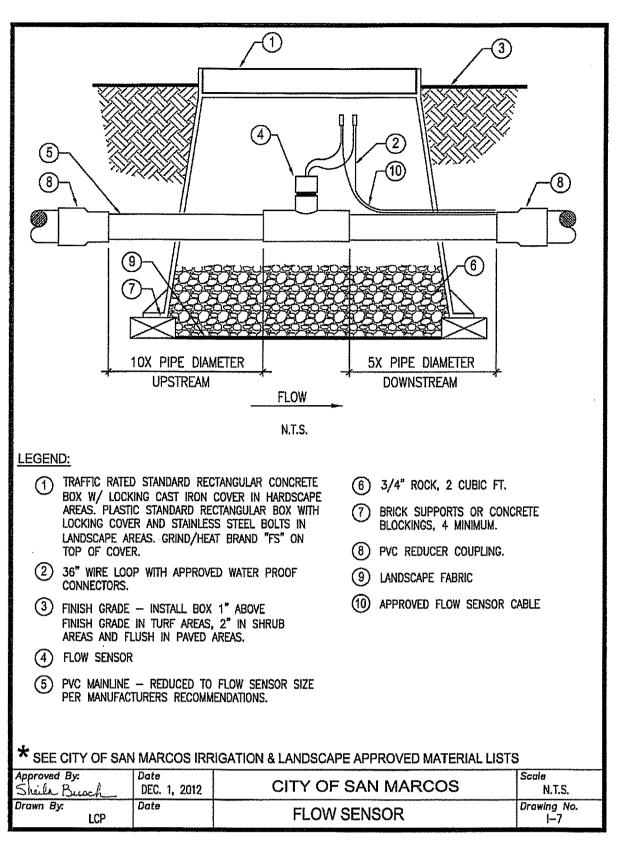


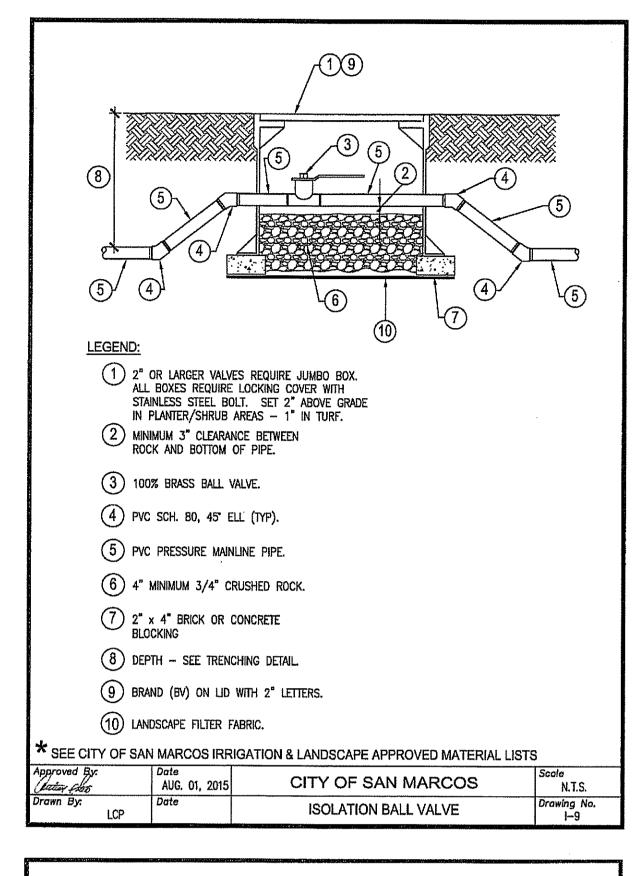


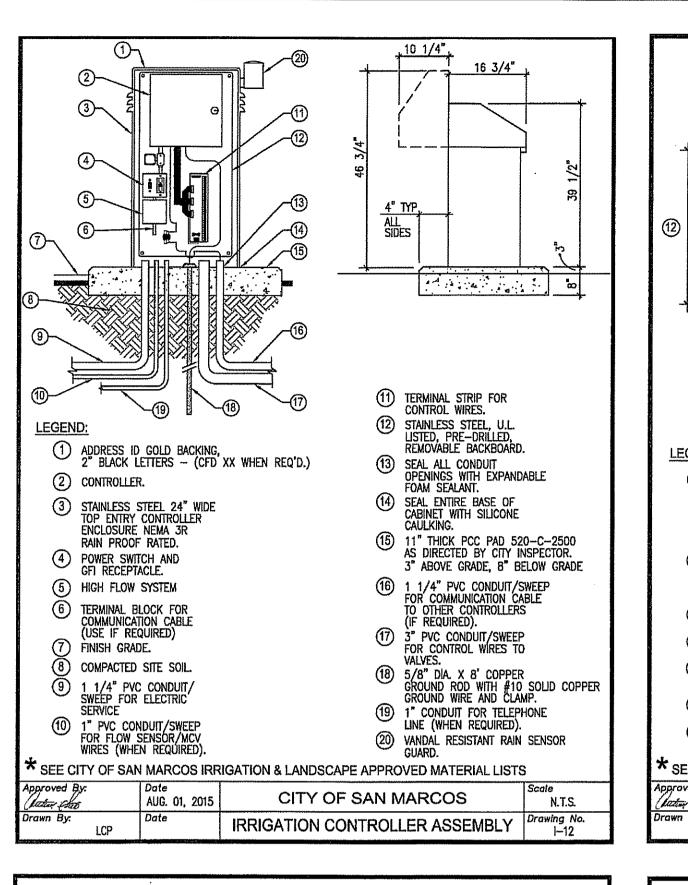


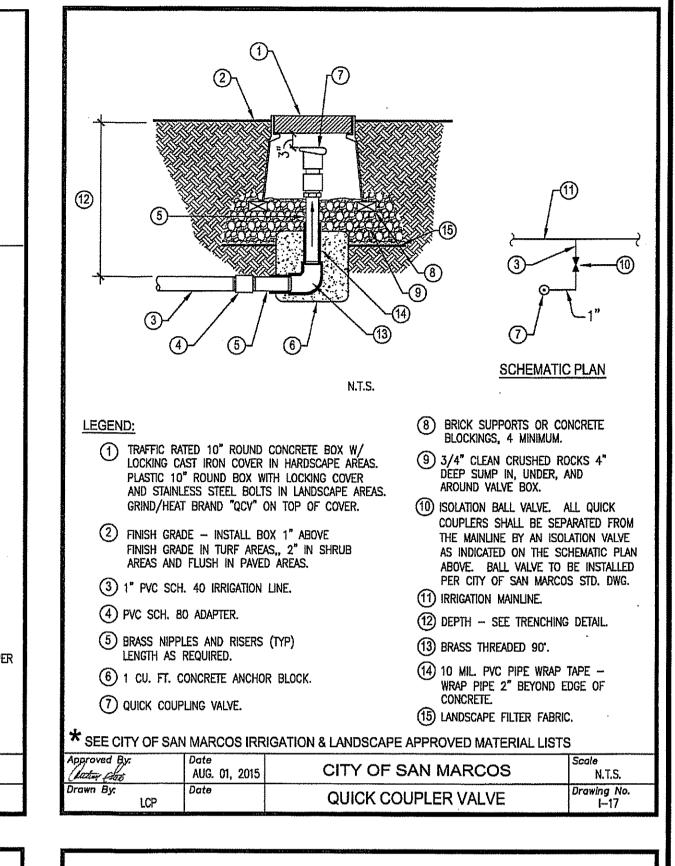


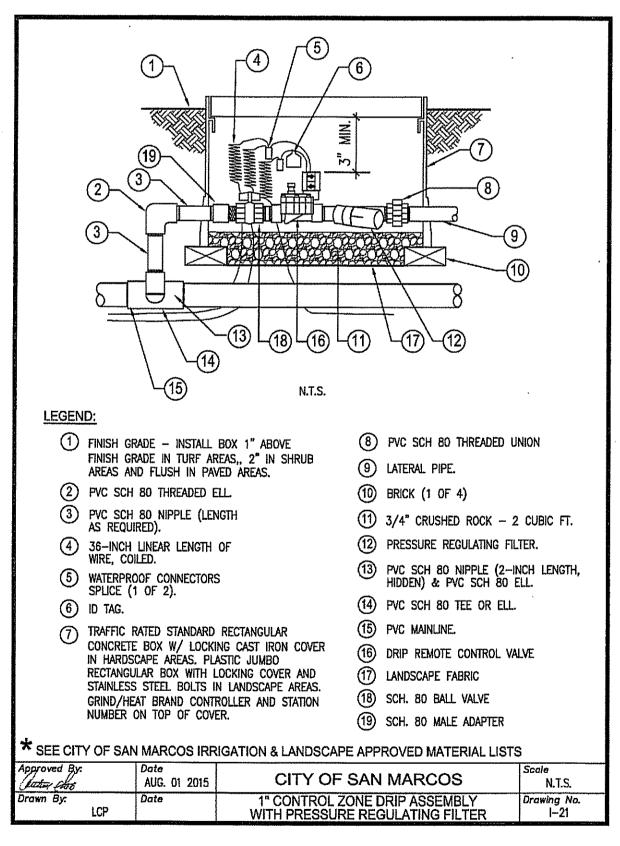

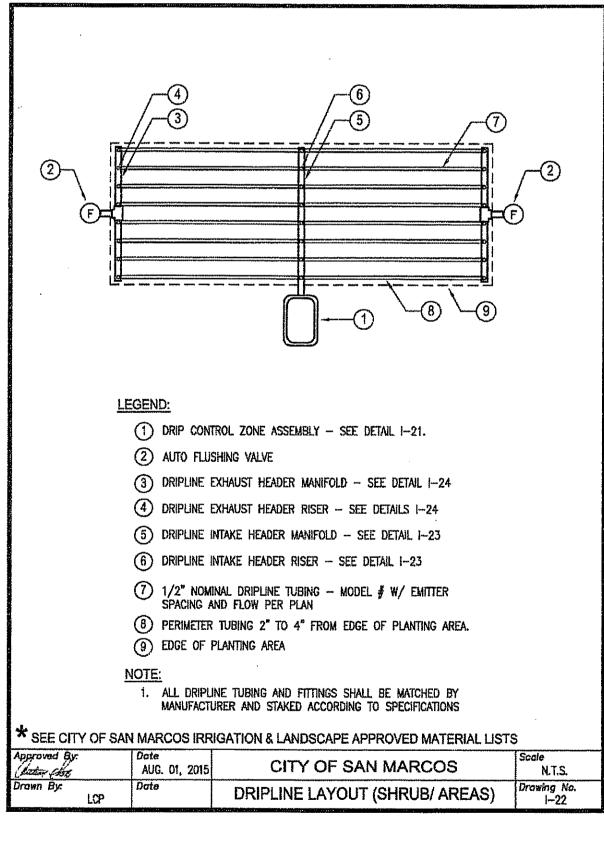

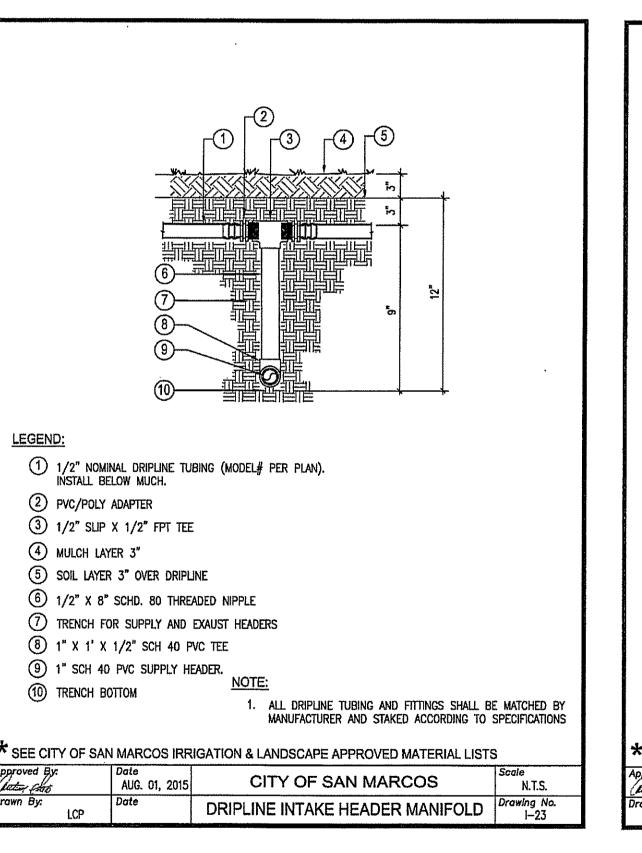

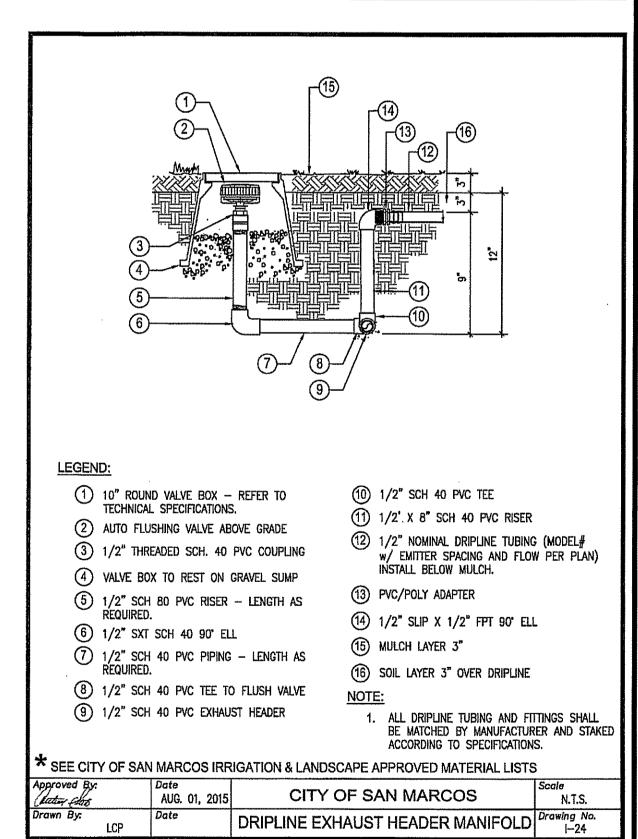

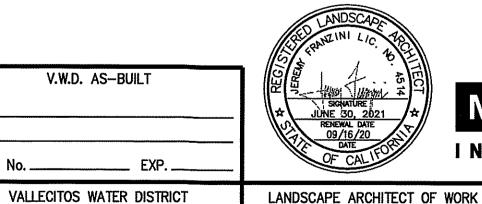

Name: JEREMY FRANZINI

LIC. NO.: 4514 exp: 06/30/21



No. Description

_Date: 09/16/20

5050 Avenida Encinas Carlsbad, CA 92008 Phone: (760) 476-9193 INTERNATIONAL MBAKERINTL.COM

CITY APPROVED CHANGES

FOR ACCEPTANCE
By: Public Works Inspector
Date:
RECOMMENDED FOR APPROVAL
By: Lewis Clapp, Senior Civil Engineer
R.C.E.: 76583 exp.: 12/31/2022 Date: 6/28/2/

INSPECTED AND RECOMMENDED

APPROVED FOR CONSTRUCTION	BENCH MARK	
By:	Description: CITY OF SAN MARCOS GPS PT. NO. 1017 AND GPS PT. NO. 1021 PER ROS 13928	LAI
By:	Location: PT. No. 1017: N1992455.016 E6270654.355 PT. No. 1021: N1992450.992 E6274932.043	
Date:	Elev.: 513.042 [510.736] Datum: NAVD 1988 [NGVD VWD 29]	

VWD W.O. 207141 CITY OF SAN MARCOS ENGINEERING DIVISION City Drawing No. ANDSCAPING AND IRRIGATION PLAN FOR: IP18-00009 SAN MARCOS BOULEVARD AT DISCOVERY

STREET INTERSECTION

H: \PDATA\163212\CADD\LARCH\DLV\163212-23-LDSC-4.DWG CHAABANI, ALAA 9/16/2020 11: 45 AM

JAMES H. GUMPEL, DISTRICT ENGINEER

PLAN CODE LDSC-4

Sheet 23 of 29



Tel: 760.752.7550 Fax: 760.752.7578

STANDARD IRRIGATION & LANDSCAPE PLAN NOTES FOR PUBLICLY CONSTRUCTED CAPITAL IMPROVEMENT PROJECTS (CIP) AND CAPITAL IMPROVEMENT PROJECTS HAVING COMMUNITY FACILITY DISTRICTS (CFD)

NOTE TO DESIGNERS: The following standard notes shall be included on the respective irrigation and landscape plan sheets of all publicly constructed Capital Improvement Projects (CIP). Project specific notes for items not covered by the City's irrigation and landscape special provisions, standard drawings, approved materials list, and these standard notes may be added to the plans as approved by the Public Works Department. These standard notes shall not be amended without approval from the Public Works Department.

STANDARD IRRIGATION NOTES:

- 1. The Contractor shall schedule a landscape preconstruction meeting with the Public Works Department Landscape Inspector via the Engineering Department Inspector prior to the commencement of irrigation work. The Contractor and its landscape subcontractor shall attend the meeting.
- 2. The work shall be constructed in accordance with the Contract Documents. including but not limited to the plans, special provisions, the city's irrigation and landscape standard drawings, the city's approved materials list, the Standard Specifications for Public Works Construction, and these standard irrigation notes.
- 3. The Contractor shall submit a complete materials list and associated catalogue cuts for all irrigation and landscape materials to be incorporated in the Work prior to start of construction. The submittal shall be in bound form.
- 4. Irrigation plans are diagrammatic. The actual location of irrigation improvements shall be in planted areas where possible. Locations of irrigation improvements are subject to the Public Works Department approval prior to installation. Irrigation controllers shall be installed "outside" of irrigation coverage in locations approved by the Public Works Department.
- 5. The Contractor shall schedule inspections twenty four (24) hours in advance of the work being ready for inspection unless otherwise approved by the Landscape Inspector. Call (760) 752-7550 x3350 to schedule inspections. If the work is not ready for inspection on the scheduled date and time the Contractor shall reschedule the inspection as above. The City may charge the Contractor for rescheduled inspections and withhold further inspections until such time as the Contractor pays the reinspection fee.

rev. 9/29/11

- The above requirements are in addition to any warranty requirements set forth in the Contract Documents.
- 14. When the Contract Documents require security fencing for the project the Contractor shall include in its rental agreement with the fencing company the assumption of the fence rental by the City at the same unit price/cost established in the Contractor's original rental agreement so that the fence may remain in place until the City's 90 or 120 calendar day maintenance period ends. The cost of the rental fence during the City's maintenance period shall be borne by the City.

BUILDING AND GROUNDS NOTES:

- 1. All public playground equipment supplied to a project shall comply with all applicable provisions of the current "Handbook for Public Safety" published by Consumer Product Safety Commission (CPSC) and ASTM F1487-98, "Standard Consumer Safety Performance Specifications for Playground Equipment for Public Use" published by the American Society of Testing and Materials (ASTM). All products shall bear the certification seal of the International Play Equipment Manufacturers Association (IPEMA). All designs shall meet or exceed the most current edition of the Americans with Disabilities Act (ADA) "Final Guidelines for Play Areas". All manufacturers must be ISO certified.
- 2. Play equipment, structures, and surfaces shall be installed by a contractor certified by the Consumer Products Safety Commission.
- 3. Play equipment, structures, and surfaces shall be inspected, audited, and certified by an independent inspector certified by the Consumer Products Safety Commission. The audit and certification shall be submitted to the Public Works
- Department prior to the acceptance of the maintenance and establishment period. 4. All improvements shall meet all requirements of the American Disabilities Act.

Note to Designer: Changes to previous Irrigation and Landscape Design Standards are designated in gray font.

V.W.D. AS-BUILT

VALLECITOS WATER DISTRICT

6. Irrigation inspections are required for the following:

- a. Pressure main layout including controller and backflow preventer
- b. Excavation and bedding including control and communication wiring. Mainline pressure test (see required submittals above).
- d. Lateral lines and terminal appurtenances layout and installation.
- e. Preliminary coverage test prior to planting.
- f. Final irrigation coverage test after planting. 7. Control wiring shall be color coded and labeled at the controller and all junction and valve boxes to correspond to the appropriate station. Install three (3) additional control wires from the controller to the end of each mainline run leaving 3' minimum of slack at both ends.
- 8. All threaded fittings require Teflon tape.
- 9. Contractor shall verify and coordinate locations of irrigation water services and irrigation controller electrical service locations with other trades to ensure they correspond with irrigation water points of connection and controller locations.
- 10. Excavation for new improvements in or through existing landscaped areas shall be performed by hand, unless otherwise approved by the Public Works Department, and shall be outside of existing tree drip lines.
- 11. Controller and communication wire splices shall only be made with Public Works Department approval and, when approved, shall only be made in an approved box with a minimum of 3' loop (6' of wire).
- 12. Irrigation controllers shall be as shown on the plans. Each controller assembly shall include remote receiver card and remote control transmitter.
- 13. The Contractor shall submit the controller assembly fabricator's installation certification to the Public Works Department prior to coverage test inspection.
- 14. Contractor shall provide accurate and current as-built drawings at the time of the mainline pressure test inspection to facilitate the inspection. 15. Pressure mainlines shall be center loaded and not backfilled leaving joints visible
- until such time as the pressure test has been completed and accepted.
- 16. Pressure mainlines shall hold 150psi for a minimum of four (4) hours. 17. As-built drawings shall be kept on-site and up to date at all times.
- 18. As-built drawings shall show the locations of:
- a. Water Services and meter.
- b. Electrical Services and meter. c. Backflow assemblies.
- d. Controller assemblies.
- e. Automatic control valves. f. Remote control valves with station designation.
- g. Isolation and quick coupler valves.
- h. Pressure main lines.
- Control and communication wires.
- Lateral lines. k. Sleeves.
- 19. Contractor shall submit full size (24"x36") "redlined" as-built drawings at the time of the coverage test inspection. As-builts shall be on new plan sheets and be clean and legible. Submission of as-builts shall be made at the coverage test inspection and is precedent to start of City performed maintenance.

rev. 9/29/11

STANDARD LANDSCAPE NOTES:

- 1. The work shall be constructed in accordance with the Contract Documents including the plans, special provisions, the City's irrigation and landscape standard drawings. the City's approved materials list, the Standard Specifications for Public Works Construction, and these standard planting notes.
- 2. The Contractor shall schedule inspections twenty four (24) hours in advance of the work being ready for inspection unless otherwise approved by the Landscape Inspector. Call (760-752-7550 x3350) to schedule inspections. If the work is not ready for inspection on the scheduled date and time the Contractor shall reschedule the inspection as above. The City may charge the Contractor for rescheduled inspections and withhold further inspections until such time as the Contractor pays the reinspection fee.
- 3. Planting inspections are required for the following: a. Tree planting pit percolation tests (both fills).
 - b. Plant material layout prior to planting.
 - c. Plant material quality prior to planting. d. Amendment verification (prior to application)
 - e. Plant material installation.
 - f. Final plant material inspection (punch list developed) g. Final irrigation and landscape punch lists completion inspection.
- 4. Prior to installing plant material control weeds by watering for three (3) weeks to adequately germinate the seed bed and then apply a post emergent herbicide by a licensed applicator and wait as directed by the manufacturer before planting.
- 5. Soil samples for amendment testing shall be taken after completion of grading and prior to weed control and soil preparation at a minimum of three (3) locations approved by the Public Works Department. Tests shall be performed by an approved laboratory. Tests performed shall include but not be limited to organic matter content, N.P.K., Ph, E.C., and percent silt, sand, & clay. Test results and application recommendations shall be submitted to the Public Works Department prior to application of amendments. Amendments shall be applied pursuant to the laboratory and manufacturers recommendations.
- 6. Percolation tests shall be performed on all tree planting pits for fifteen gallon and larger trees prior to hardscape installation. Pits shall be filled with 18" of water and allowed to completely drain. Pits shall then be filled with 12" of water and allowed to drain. The second fill must drain at a minimum rate of 1" per hour for 4 hours.
- 7. Tree well drain systems shall be installed pursuant to City of San Marcos Standard Drawings when percolation tests fail.
- 8. The Contractor shall provide positive drainage in all landscape areas. 9. Trees supplied to the Project shall meet the following minimum standards:
- a. Special Provisions.
- b. Trees shall have a straight trunk with symmetrical crown.
- c. Trees shall have a substantial, single, central leader.
- d. Tree bark shall not be discolored, sunken, or swollen, and shall be free of
- cuts, scrapes, or other damage.
- e. Trees showing galleries, sun scald, or frost damage will on be accepted.
- f. The caliper of the tree shall be in proportion to the rootball.

rev. 9/29/11

- g. Trees with girdling roots wrapping around the trunk or otherwise rootbound
- will not be accepted. h. Tree trunks more than 10% off center will not be accepted.
- i. Trees shall be free of crossing branches and branches growing too close to
- one another. j. Freshly pruned trees will not be accepted.
- 10. Trees shall not be pruned unless otherwise approved by the Public Works Department.
- 11. The City will assume maintenance of all irrigation and landscaping upon Contractor's successful completion and City's acceptance of the final irrigation and landscape punch list AND completion of the final project punch list AND receipt of end of project submittals. The Contractor, at its expense, shall perform all irrigation and landscape maintenance until such time as these conditions are met. Upon meeting these conditions the City's maintenance contractor will perform the irrigation and landscape maintenance at City's expense.
- 12. The City will provide written notice to the Contractor designating the date of City's assumption of irrigation and landscape maintenance.
- 13. The City's irrigation and landscape maintenance contractor will maintain the new improvements for 90 calendar days in the case of "streetscapes" and 120 calendar days in the case of "parks" at City cost. During this time, an irrigation and landscape retention in the minimum amount of \$5,000 to maximum amount of \$15,000, as determined by the City, will be withheld from payment to the Contractor to warrant that defects in materials and workmanship on the part of the Contractor are remedied in a timely manner.

The Contractor will be notified by the City immediately upon discovery of defects in irrigation and landscape materials and workmanship and the Contractor shall take immediate action, as demanded by City, to remedy said defects. Failure of the Contractor to respond within the required time shall be cause for the City to use such funds that are available in the irrigation and landscape retention or other remedies available in the Contract Documents, such as but not limited to, making demand on performance bonds to remedy the defect.

All repairs to seeded turf or sod turf during the maintenance period shall me made at the Contractor's expense.

Should emergency repairs preclude prior notification of the Contractor, notice will be provided in due course. Costs associated with emergency repairs shall be paid by the City out of funds in the irrigation and landscape retention up to the amount remaining in the retention and any balance above this amount shall be reimbursed to the City within 10 working days of demand from the City. The City will provide the Contractor with appropriate documentation for any such repairs made.

Failure of the Contractor to make timely reimbursement to the City shall be cause for the City to make demand on the performance bond for such reimbursement.

The City will release any remaining balance of the irrigation and landscape retention upon expiration of the 90 or 120 calendar day City maintenance period.

rev. 9/29/11

Appendix B – Sample Water Efficient Landscape Worksheet.

(City Maintained Parkway Area) **WATER EFFICIENT LANDSCAPE WORKSHEET**

This worksheet is filled out by the project applicant and it is a required element of the Landscape Documentation Package.

Hydrozone # /Planting Description ^a	Plant Factor (PF)	irrigation Method ^b	Irrigation Efficiency (IE) ^c	ETAF (PF/IE)	Landscape Area (sq, ft,)	ETAF x Area	Estimated Total Water Use (ETWU)°
Regular Landsc	ape Areas		· · · · · · · · · · · · · · · · · · ·				
l Shijih e GC	0.4	Drip	0.81	0.49	2,650	1,309	43,976
Rock Mulch	0.0	None		0.0	275	0	0
				Totals	2,925	1,309	43,976
Special Landsca	pe Areas	•			Daurim Garinani Sara	AUDUM MENTER PROPERTY OF THE P	
				Totals			
<u> </u>					(SOURCE LANGUAGE CONTRACT CONT	TWU Total	43,976
			Ma	ximum All	owed Water	Allowance (MAWA) ^e	44,231
			•	•			////

. 1.) front lawn where 0.62 is a conversion 2.) low water use plantings factor that converts acre-3.) medium water use planting inches per acre per year to gallons per square foot per "MAWA (Annual Gallons Allowed) = (Eto) (0.62) [(ETAF x LA) + ((1-ETAF) x SLA)] where 0.62 is a conversion factor that converts acre inches per acre per year to gallons per square foot per year, LA is the total landscape area in square feet, SLA is the total special landscape area in square feet, and ETAF is .55 for residential areas and 0.45 for non-**ETAF Calculations** Regular Landscape Areas Total ETAF x Area Average ETAF for Regular Landscape Areas must Total Area 2,925 be 0.55 or below for residential areas, and 0.45 or below for non-residential areas. 0.45 Average ETAF All Landscape Areas Total ETAF x Area 1.309

Appendix B – Sample Water Efficient Landscape Worksheet.

(City Maintained Basin Area) WATER EFFICIENT LANDSCAPE WORKSHEET

This worksheet is filled out by the project applicant and it is a required element of the Landscape Documentation Package.

ETAF Landscape ETAF x Area Irrigation Method^b (PF/IE) Factor (PF) Efficiency (IE)a (ETWU)^o Regular Landscape Areas 1 Shrub & GC | 0.4 | Drip | 0.81 | 0.49 | 4:945 | 2:442

	1020		Totals	5,585	2,442	82,060
Special Landscape Area	S					
			•			
			Totals			
					ETWU Tota	82,060
		Ma		owed Wat	e <u>r Allowanc</u> (MAWA)	
• • • • • • • • • • • • • • • • • • • •			• • •		• • • •	

0.75 for spray hear Eto x 0.62 x ETAF x Area , where 0.62 is a conversion 2.) low water use plantings factor that converts acreinches per acre per year to gallons per square foot per. "MAWA (Annual Gallons Allowed) = (Eto) (0.62) [(ETAF x LA + ((1-ETAF) x SLA)] · where 0.62 is a conversion factor that converts acre inches per acre per year to gallons per square foot per

ETAF Calculations

Regular Landscape Areas Total ETAF x Area 5,585 Total Area Average ETAF

vear, LA is the total landscape area in square feet, SLA

and ETAF is .55 for residential areas and 0.45 for non-

is the total special landscape area in square feet.

Average ETAF for Regular Landscape Areas must be 0.55 or below for residential areas, and 0.45 or below for non-residential areas.

All Landscape Areas Total ETAF x Area Total Area

PLAN CODE LDSC-5

_Date: 09/16/20 JASON NAILON, FIRE MARSHAL JAMES H. GUMPEL, DISTRICT ENGINEER Name: JEREMY FRANZINI 3.29.2 LIC. NO.: 4514 exp: 06/30/21 Date: RCE C60160 EXP 6/30/2020 H:\PDATA\163212\CADD\LARCH\DLV\163212-24-LDSC-5.DWG CHAABANI, ALAA 9/16/2020 1:31 PM

SAN MARCOS FIRE DEPARTMENT

LANDSCAPE ARCHITECT OF WORK

Michael Baker INTERNATIONAL MBAKERINTL.COM

No. Description

5050 Avenida Encinas Carlsbad, CA 92008 Phone: (760) 476-9193

CITY APPROVED CHANGES

Public Works Inspector Date: _ RECOMMENDED FOR APPROVAL <u>App'd By Date</u> y: Lewis Clapp, Senior Civil Engineer

)ate: <u>6/28/2/</u>

INSPECTED AND RECOMMENDED

FOR ACCEPTANCE

APPROVED FOR CONSTRUCTION Isaac Etchamendy, City Engineer ___exp.: <u>09/30/2021</u> R.C.E.: 81294

Total Area


Sitewide ETAF


BENCH MARK CITY OF SAN MARCOS GPS PT. NO. 1017 AND 1021 PER ROS 13928 Location: PT. NO. 1017: N1992455.016 E6270654.355 PT. NO. 1021: N1992450.992 E6274932.043 Elev.: 513.042 [510.736] Datum: NAVD 1988 [NGVD VWD 29

CITY OF SAN MARCOS ENGINEERING DIVISION LANDSCAPING AND IRRIGATION PLAN FOR: SAN MARCOS BOULEVARD AT DISCOVERY STREET INTERSECTION

	VWD W.O. 207141					
1	City Drawing No.					
	IP18-00009					
	Sheet 24 of 29					

100%

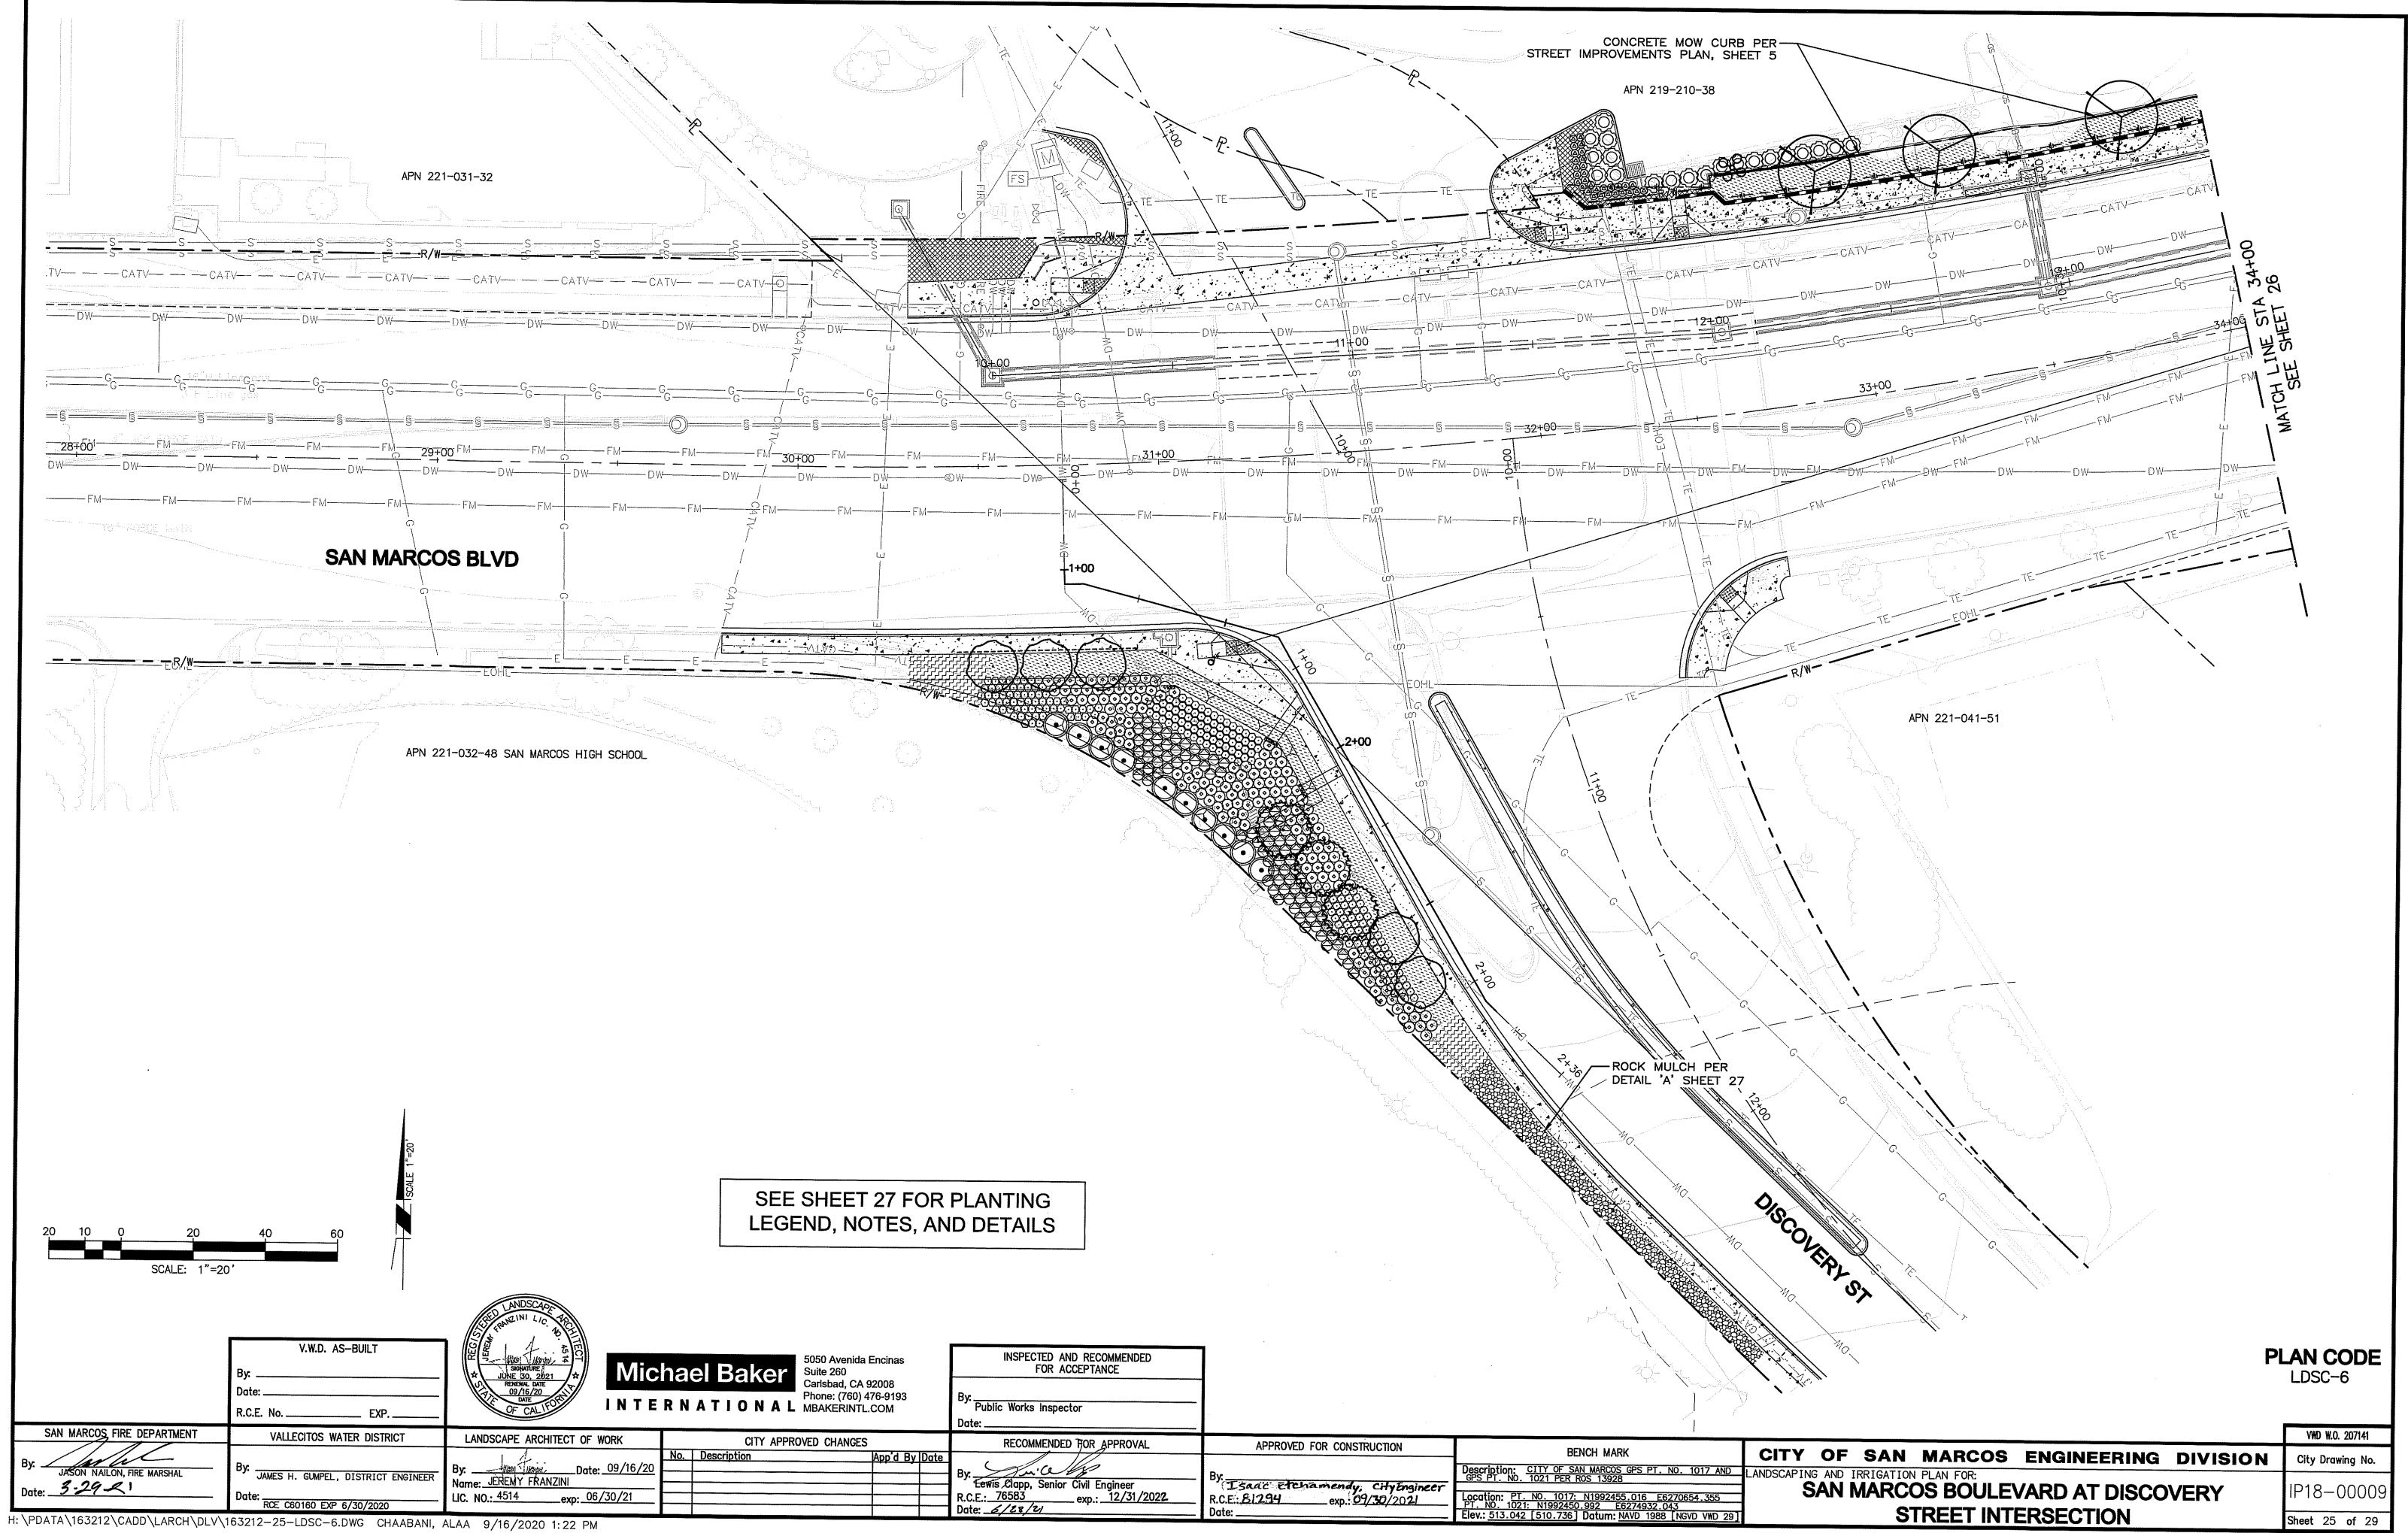

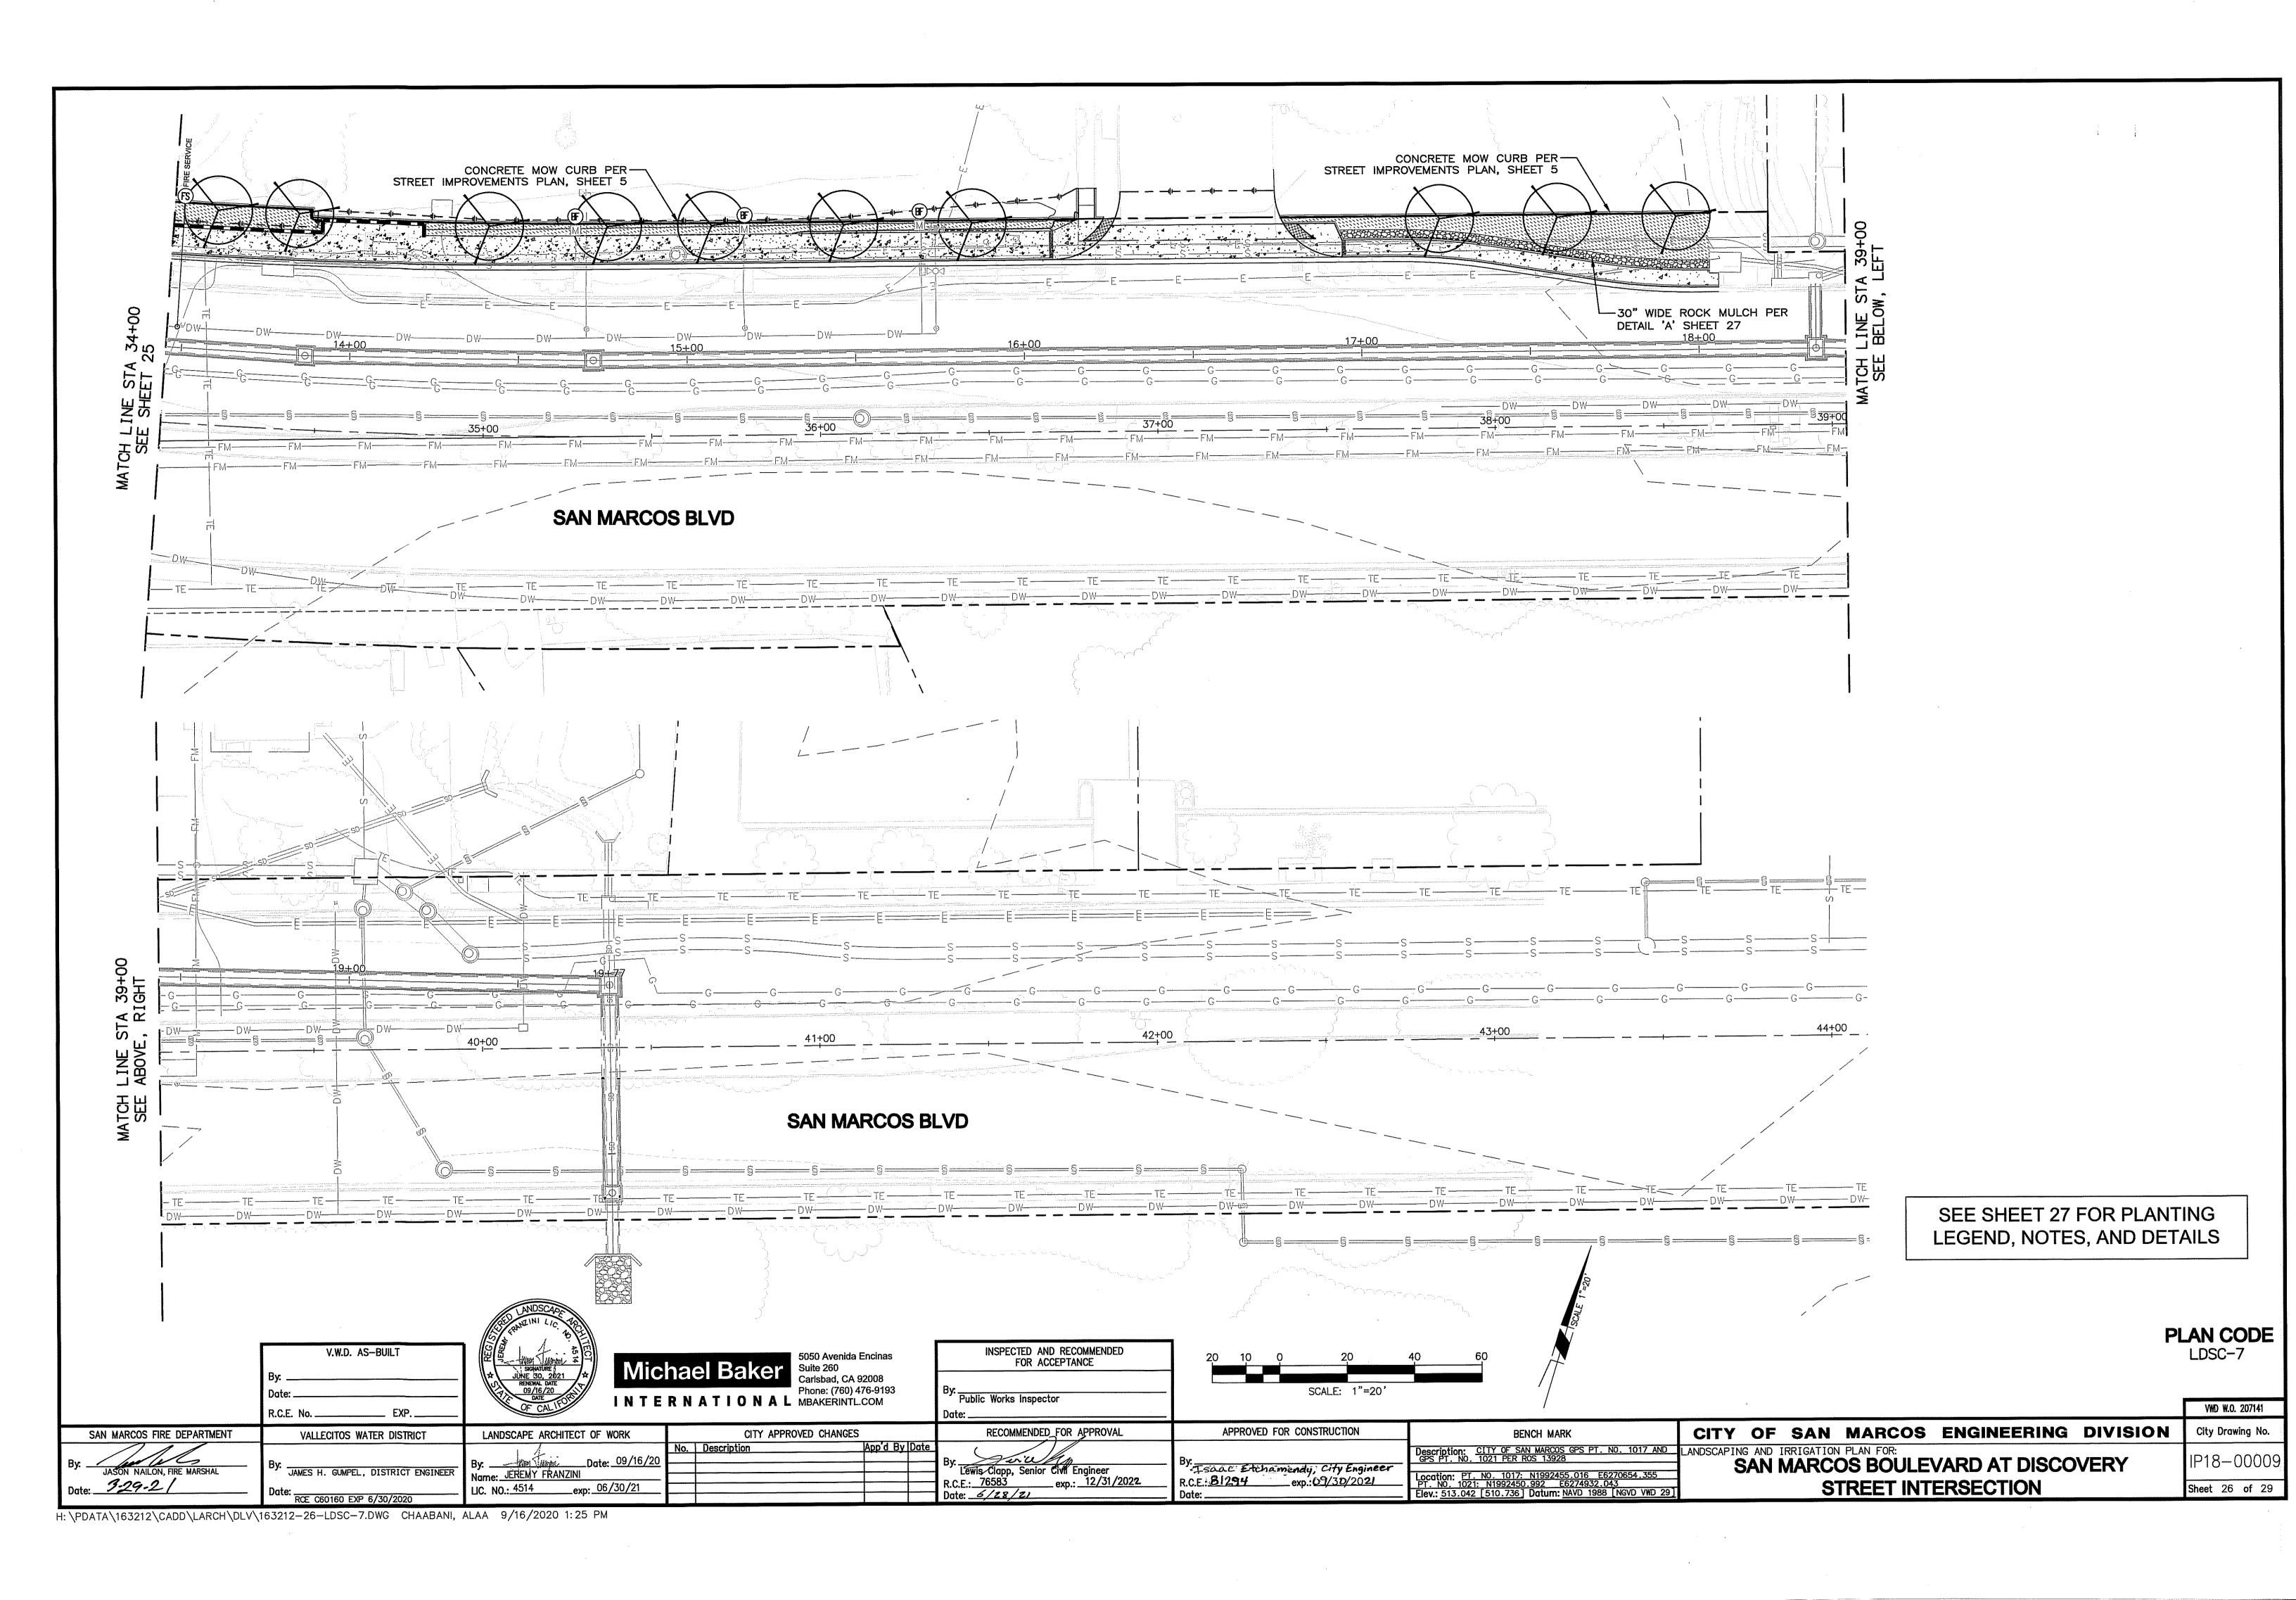

ひひひひひひ

(1) AREAS WITH GROUND COVER - FINISH SOIL GRADE TO BE

3" BELOW HARDSCAPE/PAVEMENT.

INCORPORATED INTO NATIVE SOIL.

(5) CONCRETE MOW STRIP, OR HARDSCAPE

IMPROVEMENT, AS INDICATED ON PLAN.

IMPROVEMENT, AS INDICATED ON PLAN.

(8) GROUND COVER PLANTED FROM CONTAINER

SHALL RECEIVE 2" LANDSCAPE MULCH.

SEE CITY OF SAN MARCOS IRRIGATION & LANDSCAPE APPROVED MATERIAL LISTS

CITY OF SAN MARCOS

GROUND COVER PLANTING

N.T.S.

Drawing No. L-7

HARDSCAPE/PAVEMENT.

(4) EQUAL (X) — SEE PLANT LEGEND

FOR ON CENTER SPACING.

(6) CONCRETE CURB OR HARDSCAPE

(7) SEE PLANT LEGEND FOR MINIMUM

(9) UNDISTURBED NATIVE SOIL.


MAY 1, 2010


LCP


CLEARANCE.

(2) SOIL AMENDMENTS - PER SOILS REPORT

(3) FINISH GRADE OF MULCH TO BE 1" BELOW

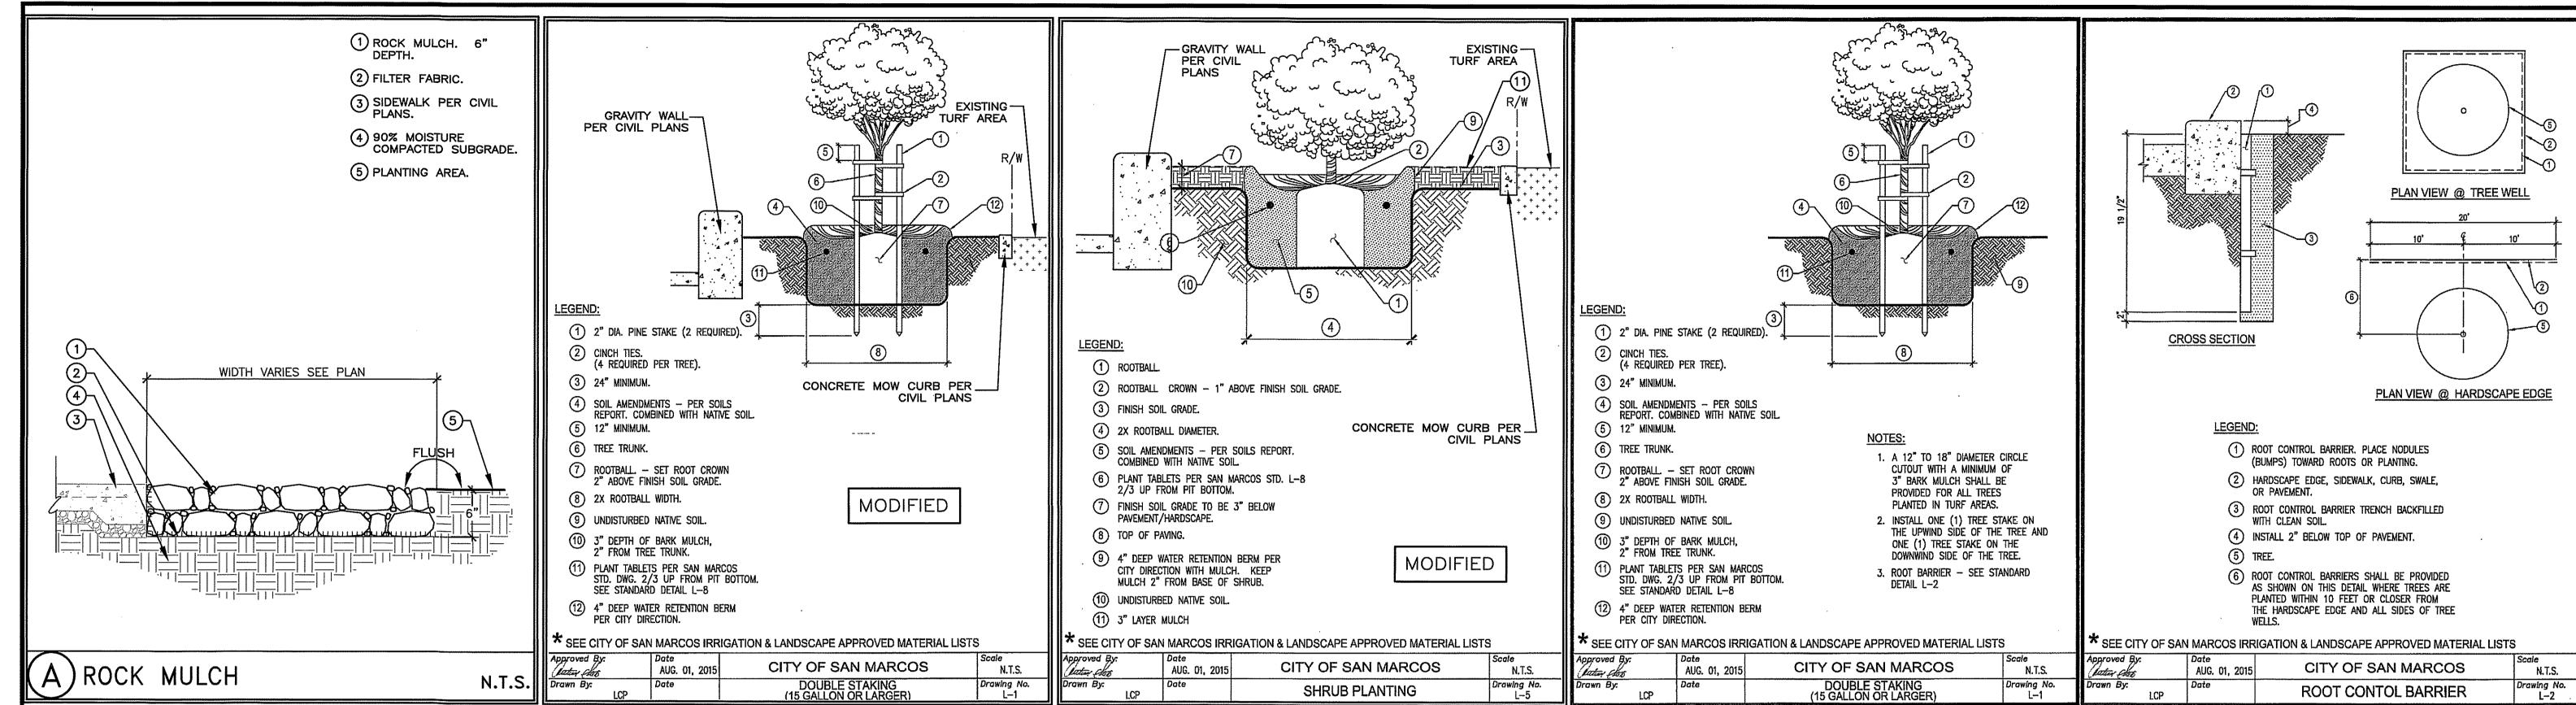

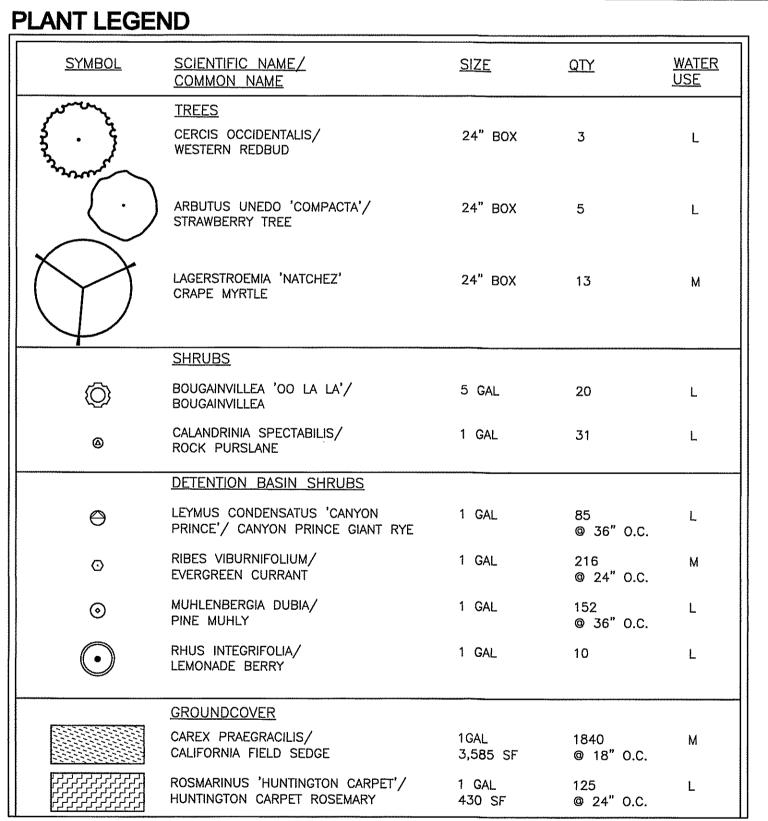

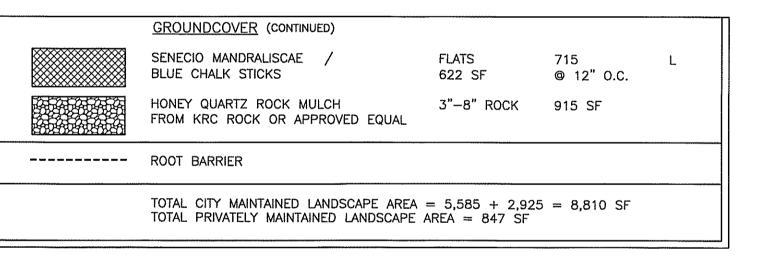

PLANTING NOTES

- 1. ALL LANDSCAPE AND IRRIGATION WORK SHALL CONFORM TO CITY SAN MARCOS LANDSCAPE STANDARDS, THE LATEST EDITION OF THE STANDARD SPECIFICATIONS FOR PUBLIC WORKS CONSTRUCTION "GREEN BOOK" (A COPY SHALL BE KEPT ON THE JOB SITE AT ALL TIMES), THE SPECIFICATION SPECIAL PROVISIONS, LOCAL CODES AND ORDINANCES, AND ALL OTHER LANDSCAPE RELATED CITY AND REGIONAL STANDARDS. ALL WORK SHALL BE SUBJECT TO THE CITY ENGINEER'S ACCEPTANCE AS A CONDITION OF COMPLETION OF WORK BY THE CONTRACTOR.
- 2. PLANT QUANTITIES ARE SHOWN FOR CONTRACTOR'S CONVENIENCE IN ESTIMATING ONLY. THE CONTRACTOR IS RESPONSIBLE FOR PROVIDING THE PLANT MATERIAL FOR EACH SYMBOL SHOWN ON THE PLANTING PLAN.
- 3. ALL WORK SHALL BE SUBJECT TO THE CITY ENGINEER'S ACCEPTANCE AS A CONDITION OF COMPLETION OF WORK BY THE
- 4. THE PLATING PLAN IS DIAGRAMMATIC. MINOR ADJUSTMENTS IN PLANT LOCATIONS MAY BE MADE AT THE DISCRETION OF THE PROJECT LANDSCAPE ARCHITECT OR THE CITY ENGINEER'S.
- 5. ALL PLANT MATERIAL SHALL BE SUBJECT TO REVIEW AND APPROVAL BY THE PROJECT LANDSCAPE ARCHITECT OR THE CITY ENGINEER'S PRIOR TO INSTALLATION. SEE THE SPECIFICATIONS FOR ADDITIONAL REQUIREMENTS.
- 6. ALL NURSERY TYING MATERIAL AND MARKING TAPES SHALL BE REMOVED AT THE TIME OF PLANTING.
- 7. THE CONTRACTOR SHALL VERIFY THE EXACT LOCATIONS OF ALL EXISTING UTILITIES, SITE CONDITIONS, STRUCTURES, PROPERTY LINES, AND SERVICES BEFORE COMMENCING WORK TO ENSURE THAT THERE IS NO DAMAGE DURING CONSTRUCTION. THE LOCATIONS OF THESE CONDITIONS SHOWN IN THESE PLANS ARE APPROXIMATE ONLY. ANY DISCREPANCIES BETWEEN THESE PLANS AND ACTUAL FIELD CONDITIONS SHALL BE REPORTED TO THE CITY ENGINEER'S. THE CONTRACTOR IS RESPONSIBLE TO REPAIR AND REPLACE ANY DAMAGE TO EXISTING UTILITIES DURING CONSTRUCTION WITH NO ADDITIONAL COST TO THE OWNER.
- 8. PLANT MATERIAL LOCATED ADJACENT TO ANY LIGHT STANDARDS, UTILITY EQUIPMENT, OR DRIVEWAYS, ETC. SHALL BE ADJUSTED TO MAINTAIN A SUITABLE CLEARANCE AS APPROVED BY THE CITY ENGINEER'S. TREES SHALL NOT BE INSTALLED OVER UNDERGROUND UTILITIES.
- 9. ALL PLANTING AREAS SHALL HAVE A 3" LAYER OF BARK MULCH PER THE SPECIFICATIONS.
- 10. SEE THE SPECIFICATION SPECIAL PROVISIONS FOR ADDITIONAL REQUIREMENTS.

09/16/20	Chael Baker Suite 260 Carlsbad, CA 92008 Phone: (760) 476-9193	FOR ACCEPTANCE By:				LDSC-8
	ERNATIONAL MBAKERINTL.COM CITY APPROVED CHANGES	Public Works Inspector Date: RECOMMENDED FOR APPROVAL	APPROVED FOR CONSTRUCTION	BENCH MARK	CITY OF SAN MARCOS ENGINEERING DIVISION	VWD W.O. 207141
Name: JEREMY FRANZINI IIC. NO. 4514 exp. 06/30/21		By: Clapp, Senior Civil Engineer R.C.E.: 76583 exp.: 12/31/2022	R.C.E.: 81294 exp.: 69/30/2021	Description: CITY OF SAN MARCOS GPS PT. NO. 1017 AND GPS PT. NO. 1021 PER ROS 13928 Location: PT. NO. 1017: N1992455.016 E6270654.355	LANDSCAPING AND IRRIGATION PLAN FOR: SAN MARCOS BOULEVARD AT DISCOVERY	IP18-0009 Sheet 27 of 29
L, DI	WATER DISTRICT LANDSCAPE ARCHITECT OF WORK By:	WATER DISTRICT LANDSCAPE ARCHITECT OF WORK LANDSCAPE ARCHITECT OF WORK CITY APPROVED CHANGES No. Description App'd By Date Nome: JEREMY FRANZINI LIC NO. 4514 APP. 06/30/21	INTERNATIONAL MBAKERINTL.COM By: Public Works Inspector Date: WATER DISTRICT LANDSCAPE ARCHITECT OF WORK CITY APPROVED CHANGES By: Public Works Inspector Date: No. Description By: Lewis Clapp, Senior Civil Engineer R.C.E.: 76583 exp.: 12/31/2022	EXP. INTERNATIONAL Phone: (760) 476-9193 MBAKERINTL.COM Public Works Inspector Date: Date: Date: Dote: 09/16/20 Name: JEREMY FRANZINI LICENDO: 4514 Date: 09/30/21 Date: 09/30/20 Phone: (760) 476-9193 MBAKERINTL.COM Phone: (760) 476-9193 MBAKERINTL.COM Public Works Inspector Date: By: Public Works Inspector Date: By: Second Civil Engineer R.C.E.; 76583 Exp. 12/31/2022 R.C.E.; 76583 Exp. 12/31/2022 R.C.E.; 81294 Exp. 12/31/2022	EXP. INTERNATIONAL Phone: (760) 476-9193 MBAKERINTL.COM WATER DISTRICT LANDSCAPE ARCHITECT OF WORK CITY APPROVED CHANGES RECOMMENDED FOR APPROVAL APPROVED FOR CONSTRUCTION Bench Mark APPROVED FOR CONSTRUCTION Bench Mark By:	EXP. INTERNATIONAL MAKERINTL.COM Date: WATER DISTRICT LANDSCAPE ARCHITECT OF WORK CITY APPROVED CHANGES RECOMMENDED FOR APPROVAL APPROVED FOR CONSTRUCTION By. John Date: 09/16/20 Nome: JEREMY FRANZINI LONG 1991 April 1991 A

LEGEND:

1) ROOTBALL

(3) FINISH SOIL GRADE.

(4) 2X ROOTBALL DIAMETER.

(2) ROOTBALL CROWN - 1" ABOVE FINISH SOIL GRADE.

5 SOIL AMENDMENTS — PER SOILS REPORT.

6 PLANT TABLETS PER SAN MARCOS STD. L-8

COMBINED WITH NATIVE SOIL.

2/3 UP FROM PIT BOTTOM.

PAVEMENT/HARDSCAPE.

(10) UNDISTURBED NATIVE SOIL.

(8) TOP OF PAVING.

(11) 3" LAYER MULCH

LCP

(7) FINISH SOIL GRADE TO BE 3" BELOW

(9) 4" DEEP WATER RETENTION BERM PER

CITY DIRECTION WITH MULCH. KEEP

AUG. 01, 2015

* SEE CITY OF SAN MARCOS IRRIGATION & LANDSCAPE APPROVED MATERIAL LISTS

CITY OF SAN MARCOS

SHRUB PLANTING


MULCH 2" FROM BASE OF SHRUB.


ALL SHRUB BEDS LESS THAN

3:1 SLOPE SHALL RECEIVE A


3" LAYER OF LANDSCAPE MULCH.

N.T.S.

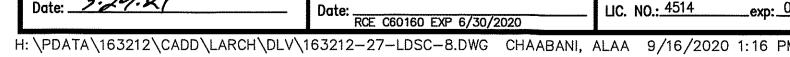

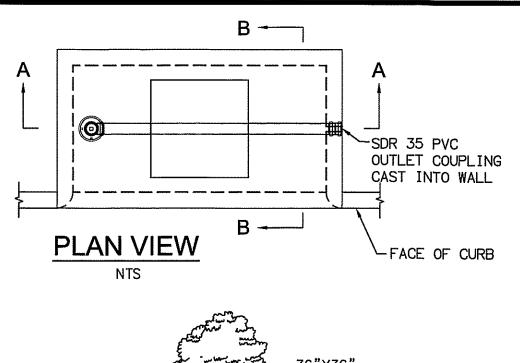


1 4 4 1

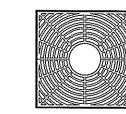

36"X36" TREE GRATE

36"X36"

TREE GRATE

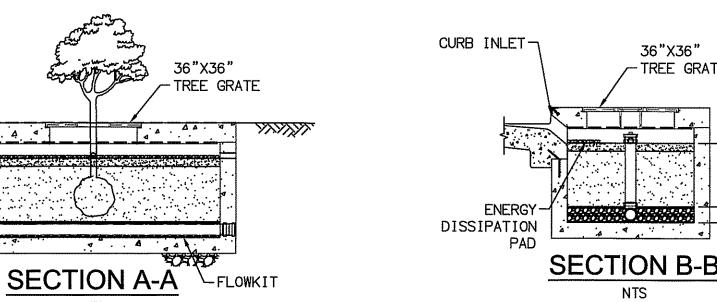


FILTERRA DETAIL

CONTRACTOR TO CONTACT AND VERIFY FILTERRA DETAIL AND SPECIFICATIONS BEFORE ORDER THE UNIT.


2' MEDIA

AND MULCH

16" DRAIN ROCK

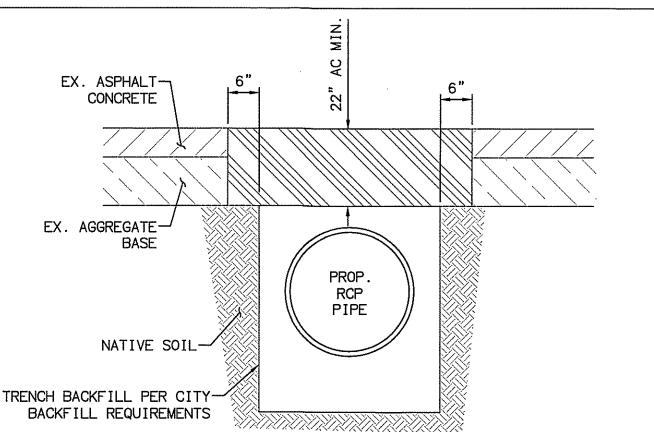

RCP PAVEMENT SECTION DETAIL

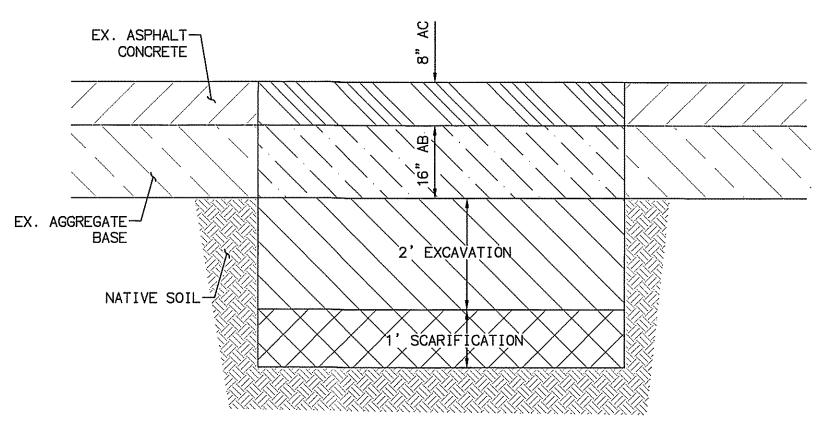

PROPOSED PAVEMENT SECTION DETAIL

1704 6 177

Name: JOSH C. STONE

R.C.E.: C60755 exp: 12/31/22

V.W.D. AS-BUILT \★\Exp. 12-31-22/★/ _ EXP. __ VALLECITOS WATER DISTRICT ENGINEER OF WORK

Michael Baker INTERNATIONAL MBAKERINTL.COM

No. Description

5050 Avenida Encinas Carlsbad, CA 92008 Phone: (760) 476-9193

CITY APPROVED CHANGES

Public Works Inspector RECOMMENDED FOR APPROVAL App'd By Date By: Lewis Clapp, Senior Civil Engineer

INSPECTED AND RECOMMENDED

FOR ACCEPTANCE

exp.: 12/31/2022

SECTION (_____)

Filterra - Vault Configuration Bioretention System Standard Specification

In accordance with the requirements of the plans and contract documents.

1.1 This item shall govern the furnishing and installation of the Filterra* Bioretention System by Contech Engineered Solutions LLC, complete and operable as shown and as specified herein,

1.2 Contractor shall furnish all labor, materials, equipment and incidentals necessary to install

the bioretention system, appurtenances and incidentals in accordance with the Drawings

1.3 Bioretention system shall utilize the physical, chemical and biological mechanisms of an

1.4 Bioretention system shall be capable of stand-alone stormwater treatment. No pretreatment

1.5 The bioretention system shall be of a type that has been installed and in use for a minimum

of five (5) consecutive years preceding the date of installation of the system. The

Manufacturer shall have been, during the same consecutive five (5) year period, engaged in

the engineering design and production of systems deployed for the treatment of storm water

runoff and which have a history of successful production, acceptable to the Engineer of

Record and/or the approving Jurisdiction. The Manufacturer of the Filterra Bioretention

1.7.1 ASTM C857: Standard Practice for Minimum Structural Design Loading for

1.7.2 ASTM C858: Standard Specification of Underground Precast Concrete Utility

1.7.3 ASTM C990: Standard Specification for Joints for Precast Box Sections Using

3.1.1 Engineered biofiltration Media flow rate shall be verified via third-party report

following TAPE or TARP protocols. The minimum treatment flow rate based on

The system shall be designed to ensure that high flow events shall bypass the

Engineered biofiltration media preventing erosion and resuspension of

on aggregated data from at least four third party field studies following TAPE or

TARP protocols. Aggregated median effluent concentration shall be less than 3.3

aggregated data from at least two third party field studies following TAPE

protocois. Aggregated median effluent concentration shall be less than 0.05

aggregated data from at least one third party field study following TAPE or TARP

protocols. Aggregated median effluent concentration shall be less than 0.54

3.1.2 The system shall remove a minimum of 86% Total Suspended Solids (TSS) based

3.1.3 The system shall remove a minimum of 70% Total Phosphorus (TP) based on

3.1.4 The system shall remove a minimum of 34% Total Nitrogen (IN) based on

3.1.5 The system shall remove a minimum of 55% Total Copper based on aggregated data from at least two third party field studies following TAPE or TARP protocols.

Aggregated median effluent concentration shall be less than 0.004 mg/L

3.1.6 The system shall remove a minimum of 43% Dissolved Copper based on

3.1.7 The system shall remove a minimum of 56% Total Zinc based on aggregated data from at least three third party field studies following TAPE or TARP protocols.

Aggregated median effluent concentration shall be less than 0.04 mg/L.

3.1.8 The system shall remove a minimum of 54% Dissolved Zinc based on aggregated

Aggregated median effluent concentration shall be less than 0.003 mg/L.

3.1.9 The system shall remove a minimum of 87% Total Petroleum Hydrocarbons based

data from at least one third party field study following TAPE or TARP protocols.

on aggregated data from at least one third party field study following TAPE or

TARP protocols. Aggregated median effluent concentration shall be less than 0.71

aggregated data from at least one third party field study following TAPE or TARP protocols. Aggregated median effluent concentration shall be less than 0.003

Contech Engineered Solutions LLC

9025 Centre Pointe Drive

West Chester, OH, 45069

Tel: 1 800 338 1122

1.6 Applicable provisions of any Division shall govern work in this section.

Preformed Flexible Joint Sealants

target pollutant shall be as follows:

Oil/Grease: 50"/hr

Phosphorus: 100°/hr

TSS: 100"/hr

1.7 American Society for Testing and Materials (ASTM) Reference Specifications

Underground Precast Concrete Utility Structures

engineered biofiltration media, plant and microbe complex to remove pollutants typically

found in urban stormwater runoff. The treatment system shall be a fully equipped, pre-

constructed, drop-in-place unit designed for applications in the urban landscape to treat

1.0 GENERAL

and as specified herein.

contaminated runoff from impervious surfaces.

to biofiltration media shall be required.

System shall be, without exception:

Structures

APPROVED FOR CONSTRUCTION

BENCH MARK Description: CITY OF SAN MARCOS GPS PT. NO. 1017 AND CONSTRUCTION DETAILS FOR: GPS PT. NO. 1021 PER ROS 13928 C.E.: 81294 exp.: 69/30/2021 Location: PT. NO. 1017: N1992455.016 E6270654.355
PT. NO. 1021: N1992450.992 E6274932.043
Elev.: 513.042 [510.736] Datum: NAVD 1988 [NGVD VWD 29

CITY OF SAN MARCOS ENGINEERING DIVISION SAN MARCOS BOULEVARD AT DISCOVERY STREET INTERSECTION

2.1.5 Vegetation shall comply with the type and size required by the approved drawings and shall be alive and free of obvious signs of disease.

2.1.6 Dissipation stone shall be 3"-6" diameter washed stones or cobbles.

2.2 Precast concrete vault shall be provided by Manufacturer or authorized supplier according to ASTM C857 and C858.

2.2.1 Vault joint sealant shall be Conseal CS-101 or approved equal, Joints shall be sealed with preformed joint sealing compound conforming to ASTM C 990.

2.2.2 If interior concrete baffle walls are provided, baffle walls shall be cast-in or sealed to the interior vault walls and floor with a polyurethane construction sealant rated for use below the waterline, SikaFlex 1a or equal. Contractor to provide

sealant material and installation unless completed prior to shipment.

2.3 Tree grates and access covers shall be cast Iron. Tree grate frames shall be galvanized steel.

2.4 Curb Nosing (where applicable) shall be galvanized steel and where specified shall be cast into a top slab designed to support AASHTO HS-20 loading at the curb.

2.5 All contractor-provided components shall meet the requirements of this section, the plans specifications and contract documents. In the case of conflict, the more stringent specification shall apply.

2.5.1 Crushed rock base material shall be six-inch minimum layer of %-inch minus rock. Compact undisturbed sub-grade materials to 95% of maximum density at +/-2% of optimum moisture content. Unsuitable material below sub-grade shall be replaced to engineer's approval.

2.5.2 Concrete shall have an unconfined compressive strength at 28 days of at least 3000 psl, with X-inch round rock, a 4-inch slump maximum, and shall be placed within 90 minutes of initial mixing.

2.5.3 Silicone Sealant shall be pure RTV silicone conforming to Federal Specification Number TT S001543A or TT S00230C or Engineer approved.

2.5.4 Grout shall be non-shrink grout meeting the requirements of Corps of Engineers CRD-C588. Specimens molded, cured and tested in accordance with ASTM C-109 shall have minimum compressive strength of 6,200 psi. Grout shall not exhibit visible bleeding.

2.5.5 Backfill material shall be %-inch minus crushed rock, or approved equal.

3.0 PERFORMANCE

3.1 Treatment Capabilities shall be verified via third-party reports following TAPE or TARP

3.2 The system shall have General Use Level Designation from Washington Department of Ecology for Basic (TSS), Phosphorus, Enhanced (Metals), and Oil/Grease and have Certification by New Jersey Department of Environment.

3.3 Quality Assurance and Quality Control procedures shall be followed for all batches of engineered biofiltration media produced. Engineered biofiltration media shall be certified by the Manufacturer for performance and composition.

1.7.4 ASTM C109: Standard Test Method for Compressive Strength of Hydraulic

1.8 Manufacturer or authorized supplier to submit shop drawings for bioretention System with

the vault, engineered biofiltration media and accessory equipment. Drawings shall include

principal dimensions, engineered biofiltration media placement, location of piping and unit

1.8.1 Manufacturer or authorized supplier shall submit installation instructions to the

1.8.2 Manufacturer or authorized supplier shall submit Operations and Maintenance

1.8.3 Before installation of the bioretention system, Contractor shall obtain the

1.9 No product substitutions shall be accepted unless submitted 10 days prior to project bid date,

written approval of the Engineer of Record for the system drawings.

or as directed by the Engineer of Record. Submissions for substitutions require review and

approval by the Engineer of Record, for hydraulic performance, impact to project designs,

equivalent treatment performance, and any required project plan and report

(hydrology/hydraulic, water quality, stormwater pollution) modifications that would be

required by the approving jurisdictions/agencies. Contractor to coordinate with the Engineer

of Record any applicable modifications to the project estimates of cost, bonding amount

determinations, plan check fees for changes to approved documents, and/or any other

2.1 Ali internal components including engineered biofiltration media, underdrain stone, PVC

bioretention system and shall be provided by Contech Engineered Solutions LLC.

underdrain piping, mulch, dissipation stone, and vegetation must be included as part of the

2.1.1 Engineered biofiltration media shall consist of both organic and inorganic

2.1.2 Underdrain stone shall be of size and shape to provide adequate bridging

2.1.3 PVC Underdrain Piping shall be SDR35 with perforation pattern designed to

2.1.4 Mulch shall be double shredded wood or bark mulch approved for use with the

Filterra Bioretention System by Contech Engineered Solutions LLC.

components. Stormwater shall be directed to flow vertically through the media

between the media and stone for the prevention of migration of fine particles.

Underdrain stone must also be able to convey the design flow rate of the system

without restriction and be approved for use in the Filterra Bioretention System

profile, saturating the full media profile without downstream flow control.

regulatory requirements resulting from the product substitution.

by Contech Engineered Solutions LLC.

convey system design flow rate without restriction.

Cement Mortars

Manual to the contractor.

3.3.1 Media particle size distribution and composition shall be verified as per relevant ASTM Standards.

3.3.2 Media pollutant removal performance shall be verified as per relevant ASTM Standards as well as a minimum of one scientific method approved by the USEPA.

3.3.3 Media hydraulic performance shall be verified as per relevant ASTM Standards.

3.3.4 Media fertility shall be verified as per a minimum of one published scientific

3.4 The Manufacturer shall ensure through third party full scale field testing of installed units that the design flow rate of the system is not reduced over time. Studies shall be performed on a minimum of 10 systems of various ages, maintenance frequencies, and land uses. At least 80% of the tested systems shall have been installed 2.5 or more years. At least 50% of the systems shall have previous maintenance intervals greater than 2 times the manufacturer's

4.0 EXECUTION

4.1 Set precast vault on crushed rock base material that has been placed in maximum 6-inch lifts, loose thickness, and compacted to at least 95-percent of the maximum dry density as determined by the standard Proctor compaction test, ASTM D698, at moisture content of +/-2% of optimum water content.

4.2 inlet and outlet pipes shall be attached to provided couplers or grouted in and connected to precast concrete vault according to Engineer's requirements and specifications. All connections to be water tight.

4.3 All throat and grate protection covers shall remain in place until the system is activated.

4.4 Contractor to cast-in-place throat inlet to convey stormwater into bioretention System according to Engineer's requirements and specifications.

4.5 Engineered biofiltration media shall be delivered installed in the vault, unless otherwise agreed upon with the Manufacturer. Contractor shall take appropriate action to protect the media from sediment and other debris during construction. The method ultimately selected shall be at Contractor's discretion and Contractor's risk.

4.5.1 If media is shipped separately from vault, Manufacturer or a Manufacturer's certified representative shall install media into the vault or be present to supervise installation in order to ensure proper installation.

4.7 Each correctly installed system shall be maintained by Manufacturer or authorized supplier for a minimum period of one year. The cost of this service shall be included in the price of 4.7.1 Annual maintenance consists of a maximum of two [2] scheduled visits.

4.6 The bioretention system shall not be placed in operation (activated) until the project site is

clean and stabilized (construction erosion control measures no longer required). The project

site includes any surface that contributes storm drainage to the system. All impermeable

surfaces shall be clean and free of dirt and debris. All catch basins, manholes and pipes shall

be free of dirt and sediment. Activation shall be provided by Manufacturer or authorized

4.7.2 Each routine maintenance visit shall consist of only the following items: system inspection; removal of foreign debris, slit, loose plant material and trash; mulch removal; engineered biofiltration media evaluation; plant health evaluation and pruning; replacement of mulch; disposal of all maintenance refuse items; and updating of maintenance records

4.8 To ensure long term performance of the bioretention system, continuing annual maintenance programs should be performed or purchased by the owner per the latest Filterra Bloretention System Operation and Maintenance manual.

> PLAN CODE CD-3

> > VWD W.O. 207141 City Drawing No.

> > > IP18-00009

Sheet 28 of 29


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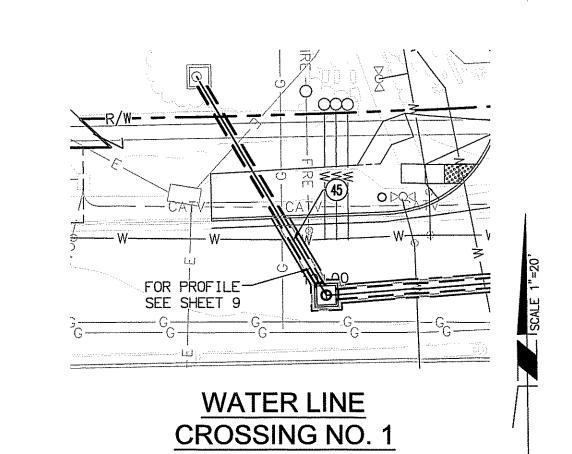
JAMES H. GUMPEL, DISTRICT ENGINEER


SAN MARCOS FIRE DEPARTMENT


JASON NAILON, FIRE MARSHAL


3-29.21




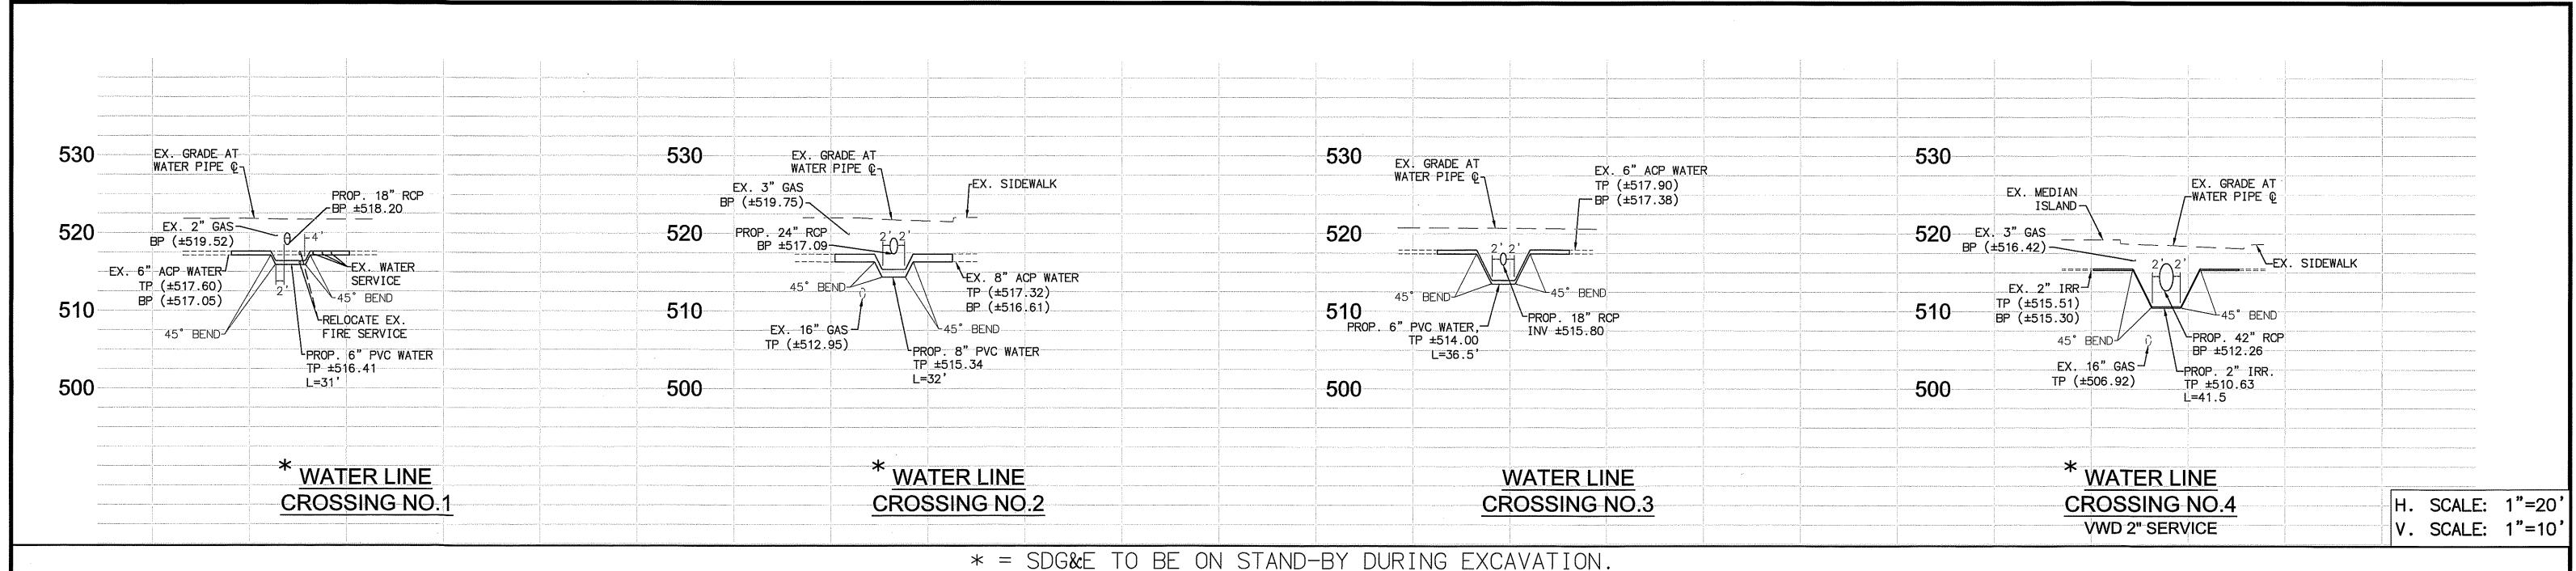

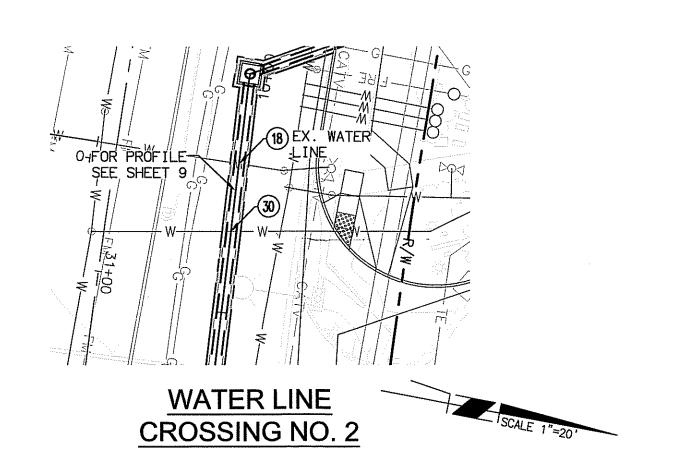

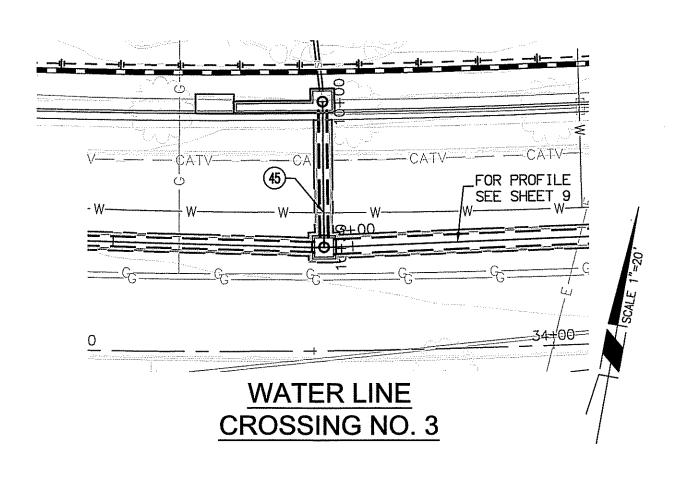

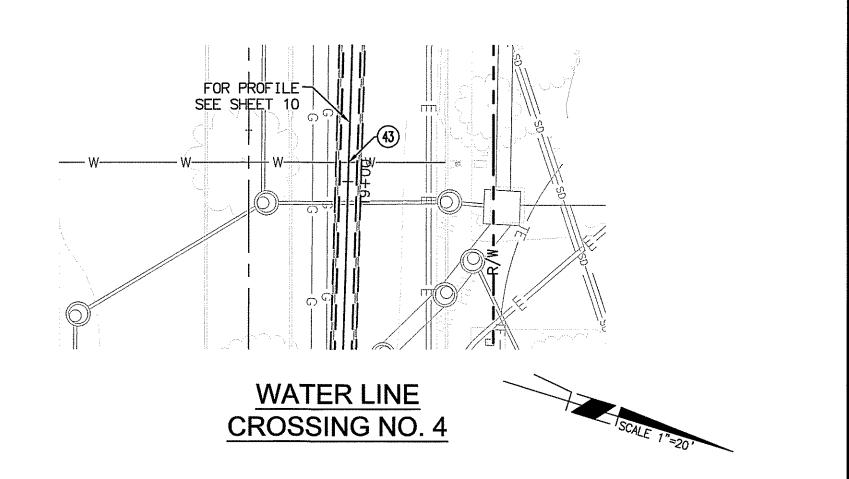

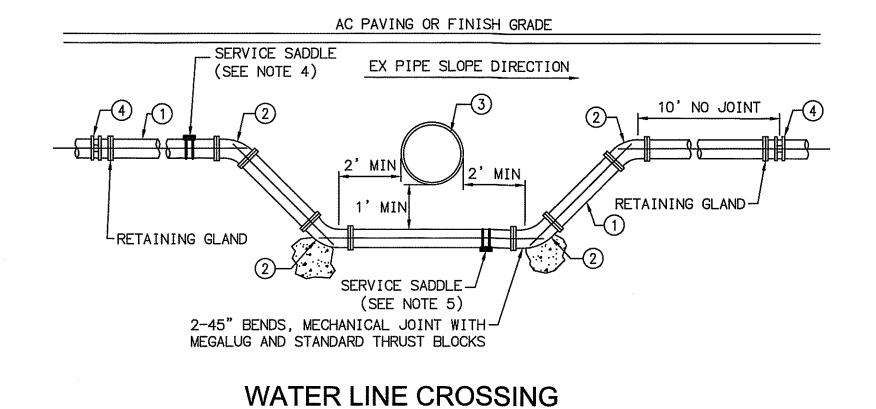

NOTES:

- 1. ALL PIPE JOINTS AT 45-DEGREE BENDS SHALL BE RESTRAINED. 2. THE THRUST AND ANCHOR BLOCKS SHALL BE PER VWD STD. DWG. W-15. 3. DIP INSTALLATION SHALL BE DOUBLE ENCASED POLYETHYLENE
- WRAPPING PER VWD STANDARDS SECTION 15056 PART 3 C4. 4. AN AUTOMATIC AIR AND VACUUM VALVE SHALL BE INSTALLED ON THE HIGH POINT OF THE OFFSET AS SPECIFIED ON THE PLAN OR DIRECTED BY VWD INSPECTOR.
- 5. A BLOW OFF MAY BE REQUIRED AT THE LOW POINT OF THE OFFSET AS SPECIFIED ON THE PLAN OR DIRECTED BY VWD INSPECTOR. 6. IF BOTTOM LENGTH EXCEEDS 18 FEET, CONNECT PIPE SECTIONS WITH
- MECHANICAL JOINT RETAINING GLAND.

MATERIAL:


- ① PVC
- 2 45" BEND MECHANICAL JOINT W/ RESTRAIN
- (3) UTILITY CONDUIT
- (4) FACTORY JOINT OR EXISTING PIPE MATERIAL X D.I. TRANSITION COUPLING

WATER LINE CROSSING TABLE:

<u>NO.</u>	STATIONS	EX PIPE INFO	PROP. PIPE INFO
1	10+39.49 SD LATERAL 1 = 30+47.72 SAN MARCOS BLVD	6" ACP	RESTRAINED 6" PVC
2	10+33.13 SD MAIN = 30+87.84 SAN MARCOS BLVD	8" ACP	RESTRAINED 8" PVC
3	10+24.80 SD LATERAL 2 = 33+52.32 SAN MARCOS BLVD	6" ACP	RESTRAINED 6" PVC
4	18+96.28 SD MAIN = 39+56.67 SAN MARCOS BLVD	2" IRR	2" IRR

CONSTRUCTION NOTES


- (18) PROTECT IN PLACE
- 30 INSTALL 8-INCH PVC WATER MAIN CROSSING PER DETAIL AND PROFILE ON SHEET 29
- 2" WATER SERVICE DIP CROSSING FOR VWD LIFT STATION METER PER DETIAL AND PROFILE ON SHEET
- 45) INSTALL 6-INCH PVC WATER MAIN CROSSING PER DETAIL AND PROFILE ON SHEET 29

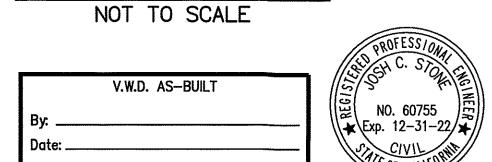

Michael Baker

5050 Avenida Encinas Carlsbad, CA 92008 Phone: (760) 476-9193 INTERNATIONAL MBAKERINTL.COM

INSPECTED AND RECOMMENDED FOR ACCEPTANCE Public Works Inspector RECOMMENDED FOR APPROVAL

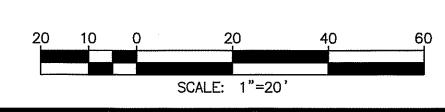

PLAN CODE WL-2

VWD W.O. 207141 CITY OF SAN MARCOS ENGINEERING DIVISION City Drawing No. IP18-00009 SAN MARCOS BOULEVARD AT DISCOVERY STREET INTERSECTION Sheet 29 of 29

	V.W.D. AS-BUILT By: Date: R.C.E. No EXP	NO. 60755 Exp. 12-31-22
SAN MARCOS FIRE DEPARTMENT	VALLECITOS WATER DISTRICT	ENGINEER OF WORK

JASON NAILON, FIRE MARSHAL

Date: 3:29.-()

JAMES H. GUMPEL, DISTRICT ENGINEER Date: RCE C60160 EXP 6/30/2022

Name: JOSH C. STONE R.C.E.: C60755 ___exp: 12/31/22

CITY APPROVED CHANGES No. Description App'd By Date

Lewis Clapp, Senior Civil Engineer

26583 exp.: 12/31/2022 Date: 6/28/21

APPROVED FOR CONSTRUCTION Isaac Etchamiendy, City Engineer
R.C.E. 81294 exp.:09/30/2021

BENCH MARK Location: PT. NO. 1017: N1992455.016 E6270654.355 PT. NO. 1021: N1992450.992 E6274932.043 Elev.: 513.042 [510.736] Datum: NAVD 1988 [NGVD VWD 29

STORM DRAIN PLAN AND PROFILE FOR:

H: \PDATA\163212_DISCOVERY ST\CADD\LAND\DLV\IMPROVE\163212-29-SD-55T.DWG LIU, LEO 3/3/2021 10:29 AM